

MCImetro ACCESS TRANSMISSION SERVICES LLC

OUTSIDE PLANT CONSTRUCTION FIBER OPTIC CABLE ROUTE

PROJECT # 095295 - NFID 2409CQDG NED - GOLDEN VALLEY NORTH FAILURE DOMAIN

SITE CODE: HENNMN

MAPLE GROVE / HEMLOCK LN - 73RD AVE TO 70TH PL / NETWORK EXTENSION

MAPLE GROVE, MN

PROJECT STATUS: ISSUED FOR PERMITTING STATUS DATE: 9/30/24

INDEX SHEET

| 1 | COVER SHEET |
|-------------|-----------------------------------|
| 2 | INDEX SHEET |
| 3 | LOCATION MAP |
| 4 | CONTACT SHEET |
| 5 | GENERAL NOTES/CLARIFICATION SHEET |
| 6 | SYMBOLS KEY |
| 7 | PROJECT CLARIFICATION SUMMARY/BOM |
| 8-10 | CONSTRUCTION DRAWINGS |
| A1 | SINGLE LINE DIAGRAM |
| T1-T6 | MCI TYPICALS |
| ADDITIONAL: | 3RD PARTY DOCUMENTATION |



PROJECT: 095295

HEMLOCK LN - 73RD AVE TO 70TH PL

| MAPLE GROVE, | MN |
|--|---|
| CLARIFICATION NO. | QUANTI |
| | |
| | |
| ACCESS TRANSMISSION SERVICES, LLC VICTOR OUTSIDE PLANT CONSTRUCTION | TITLE: FIBER OPTIC CABLE ROUTE NED - GOLDEN VALLEY NORTH FAILIRE DOMAIN |
| DATE: 9/30/24 | _ |

DATE: 9/30/24

DESIGNER: EFH
DRAWN BY: MI-TECH

REVISIONS

| | KEVISIONS | |
|----------|-------------|--------|
| DATE | DESCRIPTION | INITIA |
| 10/10/24 | CONST PACK | SJH |
| | | |
| | | |
| | | |
| | | |
| | | |
| | | |

EXCEPT AS MAY BE OTHERWISE PROVIDED BY CONTRAINESS DRAWINGS AND SPECIFICATIONS SHALL REMAINED PROPERTY OF MCI COMMUNICATIONS SERVICES, IS BOTH BEING ISSUED IN STRICT CONFIDENCE AND SHANOT BE REPRODUCED, COPIED, OR USED FOR ANY PURWITHOUT SPECIFIC WRITTEN PERMISSION.

SCALE

HORIZONTAL: NTS


VERTICAL: NTS

FILE: MAPLEGROVE_HEMLOCK-73RD.DWG

LOCATION MAP





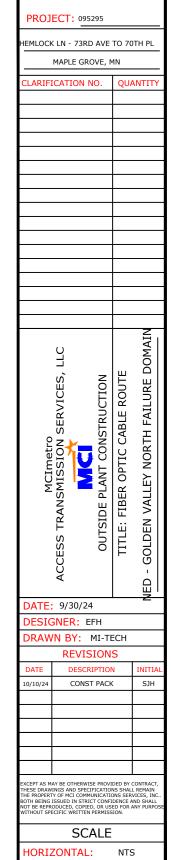

VERTICAL:

 MP
 TO MP

 SHEET
 3
 OF
 10

 FILE:
 MAPLEGROVE_HEMLOCK-73RD.DWG

| Trident Transport O | Lowe's Home A MAS HVAC The Mas |
|--|--|
| 73rd P\N Building Trades Federal Credit Union 5 73rd Ave N | Jabil Mechatronic Solutions Inc 73rd Ave N Frontier Precision Building Point Purple Heart Tril Building Point |
| GFFICE Park | Frontier Precision A CHOICE, Inc. 7-BuildingPoint 7-3rd Ave N 7-3rd Ave N 7-1st PN |
| The stand lake of the Worker Catholic Church of the Worker Catholi | 71st Ave N NEagle Lake Blvd 70th PIN |
| Carey Ln Wall to Wall Cleaning Services Maple Grove Middle School | Maple Grove Middle School Tennis Courts Pheasant Lnn Ork Ork Figure 69th PIN 69th |
| Cedar Island Shores Park 69th Ave N 69th Ave N ERIK'S - Bike Board Ski | agle Lake Blvd 69th Ave N Carr's Party Rental |
| | e Lake Dr |

CONTACT SHEET

VERIZON BUSINESS

OUTSIDE PLANT ENGINEERING:

PROJECT ENGINEER: GREG ALLEN 1200 WASHINGTON AVE MINNEAPOLIS, MN 55401

612-619-9602

SENIOR PROJECT ENGINEER: DAN SCHMIDT 1200 WASHINGTON AVE

MINNEAPOLIS, MN 55401

612-221-7997

(612)518-3008

(612)437-0172

OUTSIDE PLANT CONSTRUCTION:

PROJECT SUPERVISOR:

FIELD CONST. SUPERINTENDENT:

MANAGER:

RIGHT-OF-WAY:

AGENT: MANAGER:

CONTRACTS:

OTHERS:

PROGRAM MANAGER:

LIGHTWAVE ENGINEER:

CIVIL ENGINEER:

TERMINAL CONST. REP.: SPLICING MANAGER:

TSO MANAGER:

ENGINEERING CONTRACTOR

NAME OF FIRM:

MI-TECH SERVICES, INC.

PROJECT MANAGER:

TIM ERICKSON

ENG. / DESIGNER:

STEVEN J HOTVEDT

CONSTRUCTION CONTRACTOR

NAME OF FIRM: TBD

PROJECT COORDINATOR:

PROJECT SUPERVISOR:

RAILROADS

BRIN RPIN ROADNTY REGIONAL RAILROAD AUTHORITY

BIESARIAESATEARE ROUVA

PERSONDES STOWN AND STREET HENNEPIN.US Belanda krijanila ara opolo up.com

halley Daubthatra, 858 as 7. 1817 Composition 1690 OMAHA NE 68179

4200 BUCKINGHAM RD STE 110 FORTH WORTH TX 76155

UTILITIES

| AT&T TRANSMISSION | (612) 344-3327 |
|------------------------------|----------------|
| CENTURYLINK | (855) 742-6062 |
| CENTER POINT ENERGY | (800) 778-9140 |
| COMCAST | (800) 762-0592 |
| CITY OF MINNEAPOLIS WATER | (612) 673-5600 |
| CITY OF MINNEAPOLIS TRAFFIC | (612) 673-5600 |
| CITY OF MINNEAPOLIS SEWER | (612) 673-5600 |
| DISTRICT ENERGY | (651) 297-8955 |
| EXTENET SYSTEMS INC | (800) 778-9140 |
| HENNEPIN COUNTY PUBLIC WORKS | (406) 541-9571 |
| LEVEL 3 COMMUNICATIONS | (877) 366-8344 |
| METRO TRANSIT | (612) 349-7547 |
| METRO WASTE COMMISSION | (651) 602-4511 |
| MNDOT | (651) 366-5750 |
| QWEST COMMUNICATIONS | (800) 283-4237 |
| ROGERS COMMUNICATIONS | (877) 459-2690 |
| SPRINT/LONG DISTANCE | (800) 521-0579 |
| ST PAUL REGIONAL WATER | (651) 266-6868 |
| ST PAUL SEWER | (651) 266-9850 |
| ST PAUL TRAFFIC AND LIGHTING | (651) 266-9777 |
| ST PAUL PARKS | (651) 632-5129 |
| WINDSTREAM COMMUNICATIONS | (800) 289-1901 |
| XCEL ENERGY | (800) 848-7558 |
| ZAYO BANDWIDTH | (888) 267-1063 |
| ZAYO ENTERPRISE NETWORKS LLC | (218) 346-5500 |

CITY GOVERNMENT

BESTATIED BY DESIGNER MASKES, MN 56472 1919 1919 1919 NUN 555023 **33.5 33.5 37.5 3** 19255430 **300000** 17 **SECRETARY SANDENINS DE MOZ DE D**821N 55379 4600 VICTORIA ST N, SHOREVIEW, MN 55126

COUNTY GOVERNMENT

PMGQ@NNELL BEGINGERINGER BERNERUNG BERNAMIS 5021 OZERIAM MARIETARIA THE SHOP SHOW THE STATE OF THE SHOP SHOW THE SHOW **50.553.801NGINGINOIN5.593.02**56187

STATE GOVERNMENT

MINNESOTA DEPARTMENT OF TRANSPORTATION ANN DRIVER UTILITY PERMITS MAILSTOP 678 395 JOHN IRELAND BLVD SAINT PAUL, MN 55155

MINNESOTA DEPARTMENT OF NATURAL RESOURCES JEAN ZOCH, REAL ESTATE TECHNICIAN PERMITTING 1200 WARNER ROAD SAINT PAUL, MN 55106 651-259-5843 JEAN.ZOCH@STATE.MN.US

FEDERAL GOVERNMENT



PROJECT: 095295

IEMLOCK LN - 73RD AVE TO 70TH PL

MAPLE GROVE, MN

| CLARIFICATION NO | QUAI | VTIT) | |
|-----------------------------------|----------------------------|--------------------------------|--|
| | | | |
| | | | |
| | \dashv | | |
| | | | |
| | | | |
| ACCESS TRANSMISSION SERVICES, LLC | OUTSIDE PLANT CONSTRUCTION | TITLE: FIBER OPTIC CABLE ROUTE | IED - GOLDEN VALLEY NORTH FAILURE DOMAIN |
| DATE: 9/30/24 | | | |
| DESIGNER: FE | - | | |

DRAWN BY: MI-TECH

REVISIONS

DESCRIPTION CONST PACK

SJH

SCALE HORIZONTAL:

NTS VERTICAL: NTS

TO MP

SHEET 4 OF 10

FILE: MAPLEGROVE_HEMLOCK-73RD.DWG

GENERAL NOTES

- VERIZON BUSINESS COMPRISES THE FOLLOWING OPERATING ENTITIES
 - MCI COMMUNICATIONS SERVICES, INC.
 - MCI METRO ACCESS TRANSMISSION SERVICES, LLC
 - MCI METRO ACCESS TRANSMISSION SERVICES
 - OF VIRGINIA, INC.
 - MCI METRO ACCESS TRANSMISSION SERVICES
 - OF MASSACHUSETTS, INC.
 - METROPOLITIAN FIBER SYSTEMS OF NEW YORK, INC.
- ALL WORK TO BE PERFORMED IN STRICT ACCORDANCE WITH THE APPLICABLE CODES OR REQUIREMENTS OF ANY REGULATING GOVERNMENTAL AGENCY, VERIZON BUSINESS AND THE RIGHT-OF-WAY GRANTOR.
- LOCATIONS OF SOME OF THE PHYSICAL FEATURES WERE OBTAINED FROM DATED RAILROAD EVALU-ATION MAPS OR OTHER DRAWINGS AND MAY NOT BE AS SHOWN OR DEPICTED ON THESE DRAWINGS.
- UNDERGROUND UTILITIES HAVE BEEN PLOTTED FROM AVAILABLE RECORDS AND FIELD OBSERVATIONS BUT ARE NOT NECESSARILY EXACT. THERFORE, UTILITY LOCATIONS WILL BE VERIFIED AT LEAST 100 FEET IN ADVANCE OF TRENCHING OR PLOWING, SO THAT CHANGES IN CABLE PLACEMENT CAN BE MADE IN THE EVENT OF CONFLICT.
- ANY AND ALL IMPROVEMENTS, SUCH AS ASPHALT OR CONCRETE PAVEMENT, CURBS, GUTTERS, WALKS, DRAINAGE DITCHES, EMBANKMENTS, SHRUBS, TREES, GRASS SOD, ETC., IF DAMAGED, SHALL BE RESTORED TO ORIGINAL CONDITION.
- EQUIPMENT TYPES SPECIFIED HEREIN (IE: "BACKHOE", SWAMP PLOW" ETC.) ARE SUGGESTIONS ONLY AND ARE NOT INTENDED AS REQUIREMENTS.
- 7. SHORING OF EXCAVATIONS AND TRENCHES IN ACCORDANCE WITH OSHA REGULATIONS IS MANDATORY.
- BURIED CABLE MARKERS WILL BE PLACED AT ALL UNDERGROUND UTILITY LOCATIONS AND ALL OTHER LOCATIONS IN ACCORDANCE WITH THE CONSTRUCTION DRAWINGS AND THE OUTSIDE PLANT HANDBOOK
- ALL 2" ID CONDUIT WILL BE HDPE, OR AS SPECIFIED.
- UNDERGROUND CONDUIT WILL BE PLACED AT 36" MINIMUM COVER UNLESS OTHERWISE SPECIFIED ON THE CONSTRUCTION DRAWINGS.

CLARIFICATION NOTES

5.

- 1. STATION
- LOCATION
- CLARIFICATION NO. AND MINIMUM COVER
- QUANTITY LINEAR FOOTAGE/SQUARE FOOTAGE, SIZE OF MANHOLE/HANDHOLE SIZE OF PULL/SPLICE BOX, DIMENSION OF WALL, HEIGHT/CLASS/TYPE OF
- TYPICAL DRAWING NO. AND TYPICAL DETAIL DRAWING NUMBER
- PLANT ACCOUNTING CODE
- SPECIFIED CONDUIT, HANDHOLE/MANHOLE NO., SPECIFIED PURPOSE AND MATERIAL. BRIDGE NO. AND RAILROAD STATION, MATERIAL. POLE NO.

ADDENDUM NOTES

CLARIFICATION NOTES (CONTINUED)

| 100 | | 110 | JACK AND DRY BORE CONDUIT(S) |
|-----|------------|-----|---|
| 200 | | 210 | PLACE CONDUIT |
| | 212 213 | | PLACE HIGH DENSITY POLYETHYLENE (HDPE) ROCK ADDER |
| | 213 | | SLURRY BACKFILL ADDER |
| | 215 | | EXPOSE CONDUIT |
| | 216 | | EXPOSE COMDUIT AND RELOCATE |
| | 217 | | EXPOSE CONDUIT AND REPLACE/SUBSTITUTE |
| | 218 | | EXPOSE AND REMOVE CONDUIT |
| | 219 | | EXPOSE AND REMOVE CONDUIT (ABANDONED) |
| | 220 | | CONCRETE ENCASE |
| | 221 | | REMOVE CONCRETE ENCASEMENT |
| | 222 240 | | REMOVE CONCRETE CAP PLACE HANDHOLE |
| | 244 | | REMOVE EXISTING HANDHOLE |
| | 245 | | RELOCATE HANHOLE |
| | 0 | | REPLACE/SUBSTITUTE HANDHOLE |
| | 247 | | EXCAVATE SPLICE PIT |
| | 250 | | PLACE MANHOLE |
| | 252 | | REMOVE EXISTING MANHOLE |
| | 255 | | RELOCATE PRECAST MANHOLE |
| | 256 | | REPLACE/SUBSTITUTE PRECAST MANHOLE |
| | 260 | | CONSTRUCT WALL |
| | 270 280 | | REMOVE AND RESTORE ASPHALT REMOVE AND RESTORE CONCRETE |
| | 281 | | REMOVE AND RESTORE CONCRETE REMOVE AND RESTORE SIDEWALK |
| | 282 | | REMOVE AND RESTORE CURBING |
| | | | NET TO VE 7 HIS NEST ONE SONDING |
| 300 | | 310 | ATTACH CONDUIT TO WALL OR STRUCTURE |
| | 315 | | DETACH CONDUIT FROM WALL OR STRUCTURE |
| | 320 | | CORE BORE |
| | 330 | | ATTACH PULL/SPLICE BOX TO WALL OR STRUCTURE |
| 400 | | 410 | PULL CABLE |
| | 411 | | PULL THROUGH DUCT (INNERDUCT) |
| | 415 | | REMOVE CABLE FROM CONDUIT |
| | 420 | | REPOSITION ACTIVE CABLE SLACK |
| 500 | | 510 | DIRECT BURY CABLE |
| | 515 | | EXPOSE DIRECT BURIED CABLE |
| | 516 | | EXPOSE DIRECT BURIED CABLE AND RELOCATE |
| | 517 | | REMOVE AND DISPOSE OF CABLE |
| | 520 | | PLACE AERIAL CABLE |
| | 525 | | RELOCATE AERIAL CABLE |
| | 526 | | DELASH AERIAL CABLE RELASH AERIAL CABLE |
| | 527 528 | | REMOVE AERIAL CABLE |
| | 530 | | PLACE POLE/PUSH BRACE |
| | 535 | | REMOVE POLE/PUSH BRACE |
| 600 | | 610 | JETTING CONDUIT |
| 600 | 620 | 610 | EMBEDMENT PLOW |
| | 630 | | DIRECTIONAL BORE |
| | | | |
| 700 | | 710 | PLACE BURIED CABLE MARKERS AND SIGNS/MWCOM |
| | | | WATER CROSSING SIGNS |
| | 711 | | PLACE ISOLATOR/PROTECTION SYSTEM AT EXISTING |
| | 710 | | HANDHOLES/MANHOLES |
| | 712 714 | | REMOVE BURIED CABLE MARKER POST/HARDWARE REMOVE CONCRETE BURIED CABLE MARKER POST |
| | /14 | | KLINOVE CONCRETE BURILD CADLE MARKER PUST |

GENERAL NOTES

- 1. CONTRACTOR MUST OBTAIN LOCATES PRIOR TO DISTURBING THE
- 2. CONTRACTOR MUST HAVE A COPY OF THE APPROVED PERMIT FROM THE APPROPRIATE AGENCY ON THE JOBSITE AT ALL TIMES
- 3. ALL CABLE WILL BE PLACED AT STANDARD MINIMUM DEPTH. (MCI STANDARD IS 48" DEEP UNLESS OTHERWISE DIRECTED BY A MCI REPRESENTATIVE.)
- 4.ANY LANDSCAPING WILL BE REPLACED TO EQUAL OR BETTER THAN THAT WHICH EXISTED PRIOR TO WORK.
- 5.PROJECT SITE WILL BE PROPERLY SECURED PRIOR TO THE END OF EACH DAY.
- 6. ALL WORK IS TO BE IN ACCORDANCE WITH ALL AUTHORITIES HAVING JURISDICTION IN THE WORK ZONE.
- 7. CONTRACTORS ARE ADVISED TO CONTACT MCI FOR ANY ADDITIONAL INFORMATION OR CLARIFICATION CONCERNING SCOPE OF WORK OR THE REQUIREMENTS NECESSARY FOR PROJECT COMPLETION.
- 8.CONTRACTOR IS RESPONSIBLE TO FIELD VERIFY ALL DIMENSIONS, QUANTITIES AND EXISTING CONDITIONS PRIOR TO CONSTRUCTION. IF A SIGNIFICANT CHANGE TO THE RUNNING LINE IS NEEDED, PLEASE CONTACT YOUR MCI REPRESENTATIVE BEFORE PROCEEDING.
- 9.BEFORE CONSTRUCTION BEGINS, CONTRACTOR SHALL TAKE APPROPRIATE PRECAUTIONS TO AVOID ANY POTENTIAL OBSTRUCTIONS PRIOR TO PROCEEDING WITH WORK.
- 10. NO CONSTRUCTION ON PRIVATE PROPERTY WILL COMMENCE UNTIL APPROVAL IS GIVEN BY THE APPROPRIATE MCI EMPLOYEE.
- 11. CONTRACTOR SHALL NOT PROCEED WITH WORK UNTIL THEY HAVE RECEIVED A PURCHASE ORDER AND HAVE BEEN DIRECTED TO DO SO BY AN AUTHORIZED MCI REPRESENTATIVE.
- 12. CONTRACTOR SHALL NOT EXCEED THE PURCHASE ORDER VALUE WITHOUT AUTHORIZATION IN WRITING FROM THE APPROPRIATE MCI
- 13. AS-BUILTS WILL BE REQUIRED FOR EACH PROJECT INCLUDING CABLE FOOTAGE SEQUENTIAL'S AT EVERY ACCESS POINT, SLACK LOOP, SPLICE LOCATION, POLE AND TERMINATION POINT. CONTRACTOR SHALL PROVIDE NOTES OF ALL CHANGES IN DEPTHS, RUNNING LINES, MH/HH LOCATIONS, AND ANY OTHER APPLICABLE NOTES TO DEPICT THE WORK THAT TOOK PLACE. NOTE: ALL MAJOR CHANGES NEED TO BE PRE-APPROVED BY AN AUTHORIZED MCI EMPLOYEE PRIOR TO STARTING THE WORK.
- 14. THE SUBSURFACE UTILITY INFORMATION IN THIS PLAN IS UTILITY QUALITY LEVEL D. THIS UTILITY QUALITY LEVEL WAS DETERMINED ACCORDING TO THE GUIDELINES OF CI/ASCE 38-02. ENTITLED STANDARD GUIDELINES FOR THE COLLECTION AND DEPICTION OF EXISTING SUBSURFACE UTILITY DATA. IT SHALL BE THE CONTRACTORS RESPONSIBILITY TO UTILIZE THE GOPHER STATE ONE CALL EXCAVATION NOTICE SYSTEM REQUIRED MN STATUTE, CHAPTER 216D FOR ALL UNDERGROUND UTILITY LOCATIONS.



PROJECT: 095295

IEMLOCK LN - 73RD AVE TO 70TH PL

MAPLE GROVE, MN

| CLARIFICATION NO. | QUAI | VTIT |
|---|--------------------------------|--|
| | | |
| | | |
| ACCESS TRANSMISSION SERVICES, LLC WC OUTSIDE PLANT CONSTRUCTION | TITLE: FIBER OPTIC CABLE ROUTE | VED - GOLDEN VALLEY NORTH FAILURE DOMAIN |
| DATE: 9/30/24 | <u> </u> | Z |
| DESIGNER: EFH | | |
| DATE: 9/30/24 DESIGNER: EFH DRAWN BY: MI-TI | ECH | |
| | | |

REVISIONS

DESCRIPTION

CONST PACK SIH

SCALE HORIZONTAL:

VERTICAL:


SHEET 5 OF 10

FILE: MAPLEGROVE_HEMLOCK-73RD.DWG

TO MP

NTS

SYMBOLS KEY

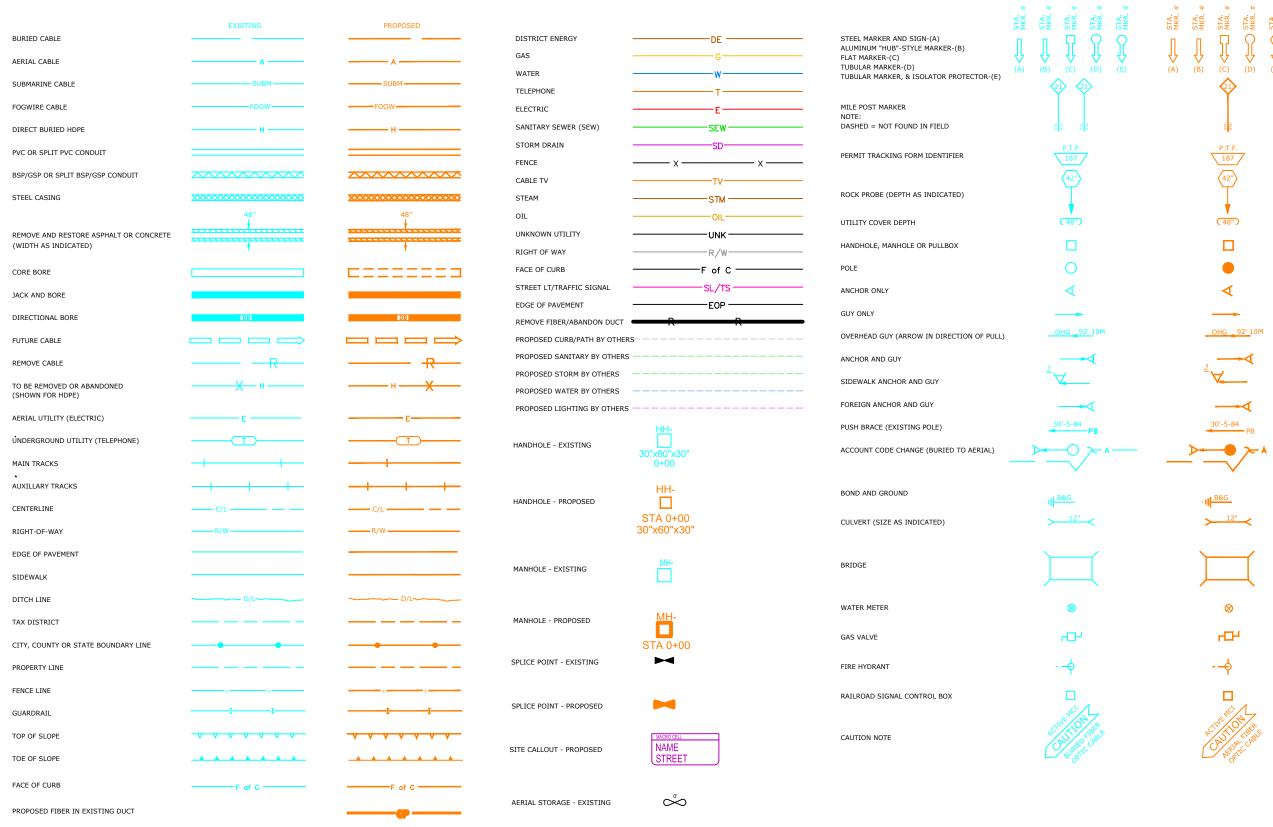

AERIAL STORAGE - PROPOSED

PROPOSED FIBER AND DUCT



PROJECT: 095295

HEMLOCK LN - 73RD AVE TO 70TH PL

MAPLE GROVE, MN

| MAPLE GROV | E, M | IN | |
|-----------------------------------|----------------------------|--------------------------------|--|
| CLARIFICATION NO | | QUAI | TIT |
| | - | | |
| | | | |
| | | | |
| | | | _ |
| ACCESS TRANSMISSION SERVICES, LLC | OUTSIDE PLANT CONSTRUCTION | TITLE: FIBER OPTIC CABLE ROUTE | JED - GOLDEN VALLEY NORTH FAILURE DOMAIN |
| DATE: 9/30/24 | | | Z |
| DESIGNER: EFF | | | |
| DRAWN BY: MI | I-TE | CH | |
| DEV/ISI/ | ONIG | 5 | |

REVISIONS

| JAIE | DESCRIPTION | INTIF |
|---------|-------------|-------|
| 0/10/24 | CONST PACK | SJH |
| | | |
| | | |
| | | |
| | | |
| | | |
| | | |

NTS


SCALE HORIZONTAL:

VERTICAL: NTS TO MP

SHEET 6 OF 10

FILE: MAPLEGROVE_HEMLOCK-73RD.DWG

CLARIFICATION SUMMARY SHEET PROJECT SPECIFIC

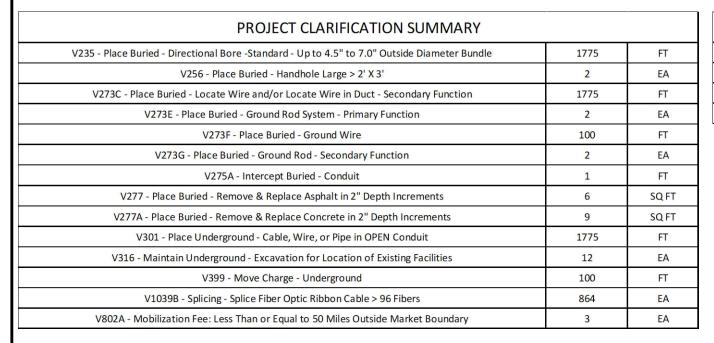

| PERMITS EXISTING | | | | H |
|----------------------------------|---------|---------|---------------|---|
| PERMIT AGENCY / PERMIT NUMBER | SHEET # | FOOTAGE | DATE APPROVED | ŀ |
| CITY OF MAPLE GROVE / GV NORTH-1 | 10 | 1,769' | XX/XX/XX | ŀ |
| HENNEPIN COUNTY / GV NORTH 2 | 8-10 | 1,665' | XX/XX/XX | Ī |
| MNDOT / GV NORTH 3 | 10 | 6' | XX/XX/XX | ŀ |

HEMLOCK LN - 73RD AVE TO 70TH PL MAPLE GROVE, MN

DATE: 9/30/24
DESIGNER: EFH

DRAWN BY: MI-TECH

DESCRIPTION

CONST PACK

SCALE

TO MP

FILE: MAPLEGROVE_HEMLOCK-73RD.DWG

NTS

OF 10

HORIZONTAL:

VERTICAL:

PROJECT: 095295

BOM / MAKE READY COST ESTIMATE PROJECT SPECIFIC

| CITY-LOCATION PROJECT NAME MAPLE GROVE TO GOLDEN VALLEY NORTH FAILURE DON | | | | | | | TOTAL AERI. | AL FOOTAGE | TOTAL | POLES | F00 | PERGROUND TAGE | TOTAL M | H'S/HH'S | TOTAL BUILDI | NG FOOTAGE | TOTAL PL | JLL BOXES | | | | | |
|--|--------------|---------------------------|--------------------|--------------|---------------------|--------------|---------------|----------------|-------------|----------------|---------------------|-----------------------------|--------------------------|---------------------------|-----------------------------|-------------------------------|----------------------|--------------------------------------|-----------------------------------|-----------------------------------|--------------------|--------------------------------|-------------------------|
| 1728F SM +3% | 864F + 3% | 576F + 3% | 432F + 3% | 288F + 3% | | 144F + 3% | 96F + 3 % | 72F + 3% | 48F + 3% | 24F + 3% | 450D SPLICE CASE | 600D SPLICE CASE | 6 PORT MHT 500' TAIL | 6 PORT MHT 1,000' TAIL | 12 PORT MHT 500' TAIL | 12 PORT MHT 1,000' TAIL | 24F PATCH PANEL | 24F PATCH PANEL E/W TAIL | 48F PATCH PANEL | 48F PATCH PANEL E/W TAIL | 72F PATCH PANEL | 72F PATCH PANEL E/W TAIL | 6 AWG GROUND WIRE |
| 0' | 0' | 0' | 2,055' | 0' | 0' | 0' | 0' | 0' | 0' | 0' | 0' | 1' | 0 | 0 | 0 | 0 | 0 | 0 | 0 | 0' | 0' | 0' | 0' |
| Hand Hol 12"x18"x1 | | Hand Holes 24"x36"x24" | Hand Ho 30"x60" | | 4'X4'X4' MANHOLE | FLOWER POT | GROUND ROD | MARKER POST | LOCATE POST | GROUND WIRE | LOCATE WIRE | 1.25"HDPE SDR-11 + 3% | 2"HDPE SDR-11 + 3% | 4" HDPE SDR- 11 + 3% | 1.25" PVC SPLIT DUCT | 2" PVC SPLIT DUCT | 4" PVC SPLIT DUCT | 1.25" PVC SPLIT 90° 48" RADIUS | 2" PVC SPLIT 90° 48" RADIUS | 4" PVC SPLIT 90° 48" RADIUS | 2" EMT | 2" EMT 90° 36" RADIUS | IN LINE GUTTER BOX |
| 0 | | 0 | 2 | | 0 | 0 | 2 | 0 | 3 | 150' | 1,828' | 0' | 1,828' | 0' | 0' | 0' | 0' | 0 | 0 | 0 | 0' | 0 | 0 |


THE SUBSURFACE UTILITY INFORMATION IN THIS PLAN IS UTILITY QUALITY LEVEL D. THIS UTILITY QUALITY LEVEL WAS DETERMINED ACCORDING TO THE GUIDELINES OF CI/ASCE 38-02, ENTITLED STANDARD GUIDELINES FOR THE COLLECTION AND DEPICTION OF EXISTING SUBSURFACE UTILITY DATA. IT SHALL BE THE CONTRACTORS RESPONSIBILITY TO UTILIZE THE GOPHER STATE ONE CALL EXCAVATION NOTICE SYSTEM REQUIRED MN STATUTE, CHAPTER 216D FOR ALL UNDERGROUND UTILITY LOCATIONS. PROJECT: 095295 IEMLOCK LN - 73RD AVE TO 70TH PL MAPLE GROVE, MN 407707 449191 408988 428235 409388 r HH-1 426053 #2 EXISTING 30"X60"X30" HH , % EXISTING 100' SLACK COIL - 432F 408475 EXISTING 100' SLACK COIL - 12F 408899 445271 7668 **EXISTING SPLICE CASE** 409274 PLACE LOCATE STATION IN HH ž ō 앜 Z BOND LOCATE WIRES & GROUND WIRE TO LOCATE STATION. Ы USE EXISTING SPLICE CASE ₹ -70TH RECORD DISCREPENCY FOUND FOR HH SIZE **70ST** RECORDS INDICATE 24"x36"x24" FIELD VERIFIED SIZE OF 30"x60"x30" OUTSIDE PLANT CONSTRUCTION
TITLE: FIBER OPTIC CABLE ROUTE F of C -F of C POTHOLE UTILITIES -0 SHEET SHEET 100' CSAH 61 (HEMLOCK LN N) 5 MATCH MATCH DATE: 9/30/24 DESIGNER: EFH DRAWN BY: MI-TECH **REVISIONS** DESCRIPTION 432F CABLE IN EXCISTING DUCT CONST PACK (1) 2" SDR-11 HDPE PULL 432F CABLE IN NEW DUCT 앜 C VZW OWNED DUCT (1) 2" SDR-11 HDPE 7000 SCALE 12F CABLE IN VZW DUCT HORIZONTAL: 1"=50' 으 VERTICAL: 1"=50' C 앜 TO MP OF 10 SHEET 8 FILE: MAPLEGROVE_HEMLOCK-73RD

THE SUBSURFACE UTILITY INFORMATION IN THIS PLAN IS UTILITY QUALITY LEVEL D. THIS UTILITY QUALITY LEVEL WAS DETERMINED ACCORDING TO THE GUIDELINES OF CI/ASCE 38-02, ENTITLED STANDARD GUIDELINES FOR THE COLLECTION AND DEPICTION OF EXISTING SUBSURFACE UTILITY DATA. IT SHALL BE THE CONTRACTORS RESPONSIBILITY TO UTILIZE THE GOPHER STATE ONE CALL EXCAVATION NOTICE SYSTEM REQUIRED MN STATUTE, CHAPTER 216D FOR ALL UNDERGROUND UTILITY LOCATIONS. PROJECT: 095295 IEMLOCK LN - 73RD AVE TO 70TH PL MAPLE GROVE, MN ō 앜 449131 408230 442613 445312 408055 444398 Ş**∠** 408434 407681 Ч POTHOLE UTILITIES -ST RESTORE SIDEWALK φ -**₹**/₩-POTHOLE UTILITIES OUTSIDE PLANT CONSTRUCTION TITLE: FIBER OPTIC CABLE ROUTE POTHOLE UTILITIES 10 **RESTORE SOD** ∞ 100' CSAH 61 (HEMLOCK LN N) 100' 125' SHEET SHEET 100' 124' c/동 5 МАТСН ТО 20' - F6 of C 22'-MATCH 11+00 -10' FO DATE: 9/30/24 PLACE 30"x60"x30" HH DESIGNER: EFH PLACE 100' SLACK COIL - 432F **DIRECTIONAL BORE 48" DEPTH** DRAWN BY: MI-TECH PLACE LOCATE STATION IN HH (1) 2" SDR-11 HDPE (1) 2" SDR-11 HDPE PLACE GROUND ROD **REVISIONS** PULL 432F CABLE IN NEW DUCT PULL 432F CABLE IN NEW DUCT DESCRIPTION POTHOLE UTILITIES -CONST PACK 2 ° ° RESTORE ASPHALT 쌓 7200 SCALE HORIZONTAL: 1"=50' 7180 VERTICAL: 1"=50' TO MP OF 10 SHEET 9 FILE: MAPLEGROVE_HEMLOCK-73RD

THE SUBSURFACE UTILITY INFORMATION IN THIS PLAN IS UTILITY QUALITY LEVEL D. THIS UTILITY QUALITY LEVEL WAS DETERMINED ACCORDING TO THE GUIDELINES OF CI/ASCE 38-02, ENTITLED STANDARD GUIDELINES FOR THE COLLECTION AND DEPICTION OF EXISTING SUBSURFACE UTILITY DATA. IT SHALL BE THE CONTRACTORS RESPONSIBILITY TO UTILIZE THE GOPHER STATE ONE CALL EXCAVATION NOTICE SYSTEM REQUIRED MN STATUTE, CHAPTER 216D FOR ALL UNDERGROUND UTILITY LOCATIONS. PROJECT: 095295 IEMLOCK LN - 73RD AVE TO 70TH PL MAPLE GROVE, MN SHIFT SLACK TO NEW HH3 FOR SPLICING 11960 100' SLACK COIL - 216F LOCATE STATION **EXISTING GROUND ROD** 216F CABLE IN EXISTING DUCT (1) 2" SDR-11 HDPE 216F CABLE IN EXISTING D POTHOLE UTILITIES -CSAH 61 (HEMLOCK LN N) 0 SHEET SHEET 7 5 MATCH. MATCH 16+00 16' POTHOLE UTILITIES **RESTORE SIDWALK** POTHOLE UTILITIES -(1) 2" SDR-11 HDPE RESTORE SOD PULL 432F CABLE IN NEW DUCT 10' UTILITY EASEMENT -/ C POTHOLE UTILITIES -RESTORE SIDWALK 10' UTILITY EASEMENT 7200 AVE HH-3 INTERCEPT EXISTING FIBER IN DUCT & SWING INTO NEW HH. SHIFT SLACK FROM HH-4 FOR SPLICING PLACE SPLICE CASE 600D 8 SCALE PLACE LOCATE STATION IN HH 73 HORIZONTAL: 1"=50' PLACE GROUND ROD VERTICAL: 1"=50' TO MP SHEET 10 OF 10 FILE: MAPLEGROVE_HEMLOCK-73RD

| MCImetro | ACCESS TRANSMISSION SERVICES, LLC | OUTSIDE PLANT CONSTRUCTION | TITLE: FIBER OPTIC CABLE ROUTE | VED - GOLDEN VALLEY NORTH FAILURE DOMAIN |
|-----------|-----------------------------------|----------------------------|--------------------------------|--|
| DATE: | 9/30/2 | 24 | | -z - |
| DESIG | SNER: | EFH | | |
| DRAW | N BY: | MI-TE | ECH | |
| | REV1 | ISION | S | |
| DATE | DESC | CRIPTION | V | INITIA |
| 0/10/24 | CON | IST PACK | | SJH |
| | | | | |
| | | | | |
| | | | | |
| | | | | |
| | | | | |
| | | | | |
| CEPT AS M | AY BE OTHER | WISE PROVI | DED BY | CONTRACT, |

SINGLE LINE DIAGRAM

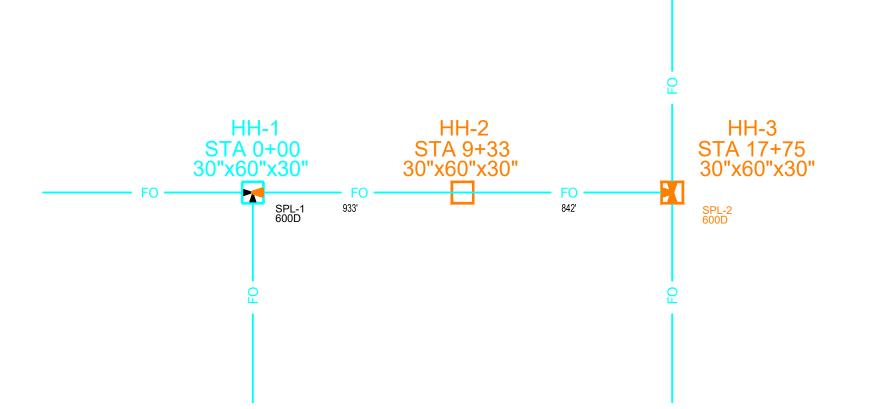



PROJECT: 095295

HEMLOCK LN - 73RD AVE TO 70TH PL

MAPLE GROVE, MN

| CLARIFICATION NO. | QUANTITY |
|--|--|
| | |
| | |
| ACCESS TRANSMISSION SERVICES, LLC ACCESS PLANT CONSTRUCTION | TITLE: FIBER OPTIC CABLE ROUTE NED - GOLDEN VALLEY NORTH FAILURE DOMAIN |

DATE: 9/30/24

DESIGNER: EFH DRAWN BY: MI-TECH

REVISIONS

| DATE | DESCRIPTION | INITIA |
|----------|-------------|--------|
| 10/10/24 | CONST PACK | SJH |
| | | |
| | | |
| | | |
| | | |
| | | |
| | | |

SCALE

HORIZONTAL: 1"=50'

VERTICAL: 1"=50'

TO MP SHEET A1 OF ??


FILE: MAPLEGROVE_HEMLOCK-73RD

THE SUBSURFACE UTILITY INFORMATION IN THIS PLAN IS UTILITY QUALITY LEVEL D. THIS UTILITY QUALITY LEVEL WAS DETERMINED ACCORDING TO THE GUIDELINES OF CI/ASCE 38-02, ENTITLED STANDARD GUIDELINES FOR THE COLLECTION AND DEPICTION OF EXISTING SUBSURFACE UTILITY DATA. IT SHALL BE THE CONTRACTORS RESPONSIBILITY TO UTILIZE THE GOPHER STATE ONE CALL EXCAVATION NOTICE SYSTEM REQUIRED MN STATUTE, CHAPTER 216D FOR ALL UNDERGROUND UTILITY LOCATIONS. PROJECT: 095295 IEMLOCK LN - 73RD AVE TO 70TH PL MAPLE GROVE, MN 407707 449191 408988 428235 409388 - HH-1 426053 42 EXISTING 30"X60"X30" HH ر م EXISTING 100' SLACK COIL - 432F 408475 EXISTING 100' SLACK COIL - 12F 408899 445271 7668 **EXISTING SPLICE CASE** 409274 PLACE LOCATE STATION IN HH ž ₹ 앜 Z BOND LOCATE WIRES & GROUND WIRE TO LOCATE STATION. Ы USE EXISTING SPLICE CASE ₹ I RECORD DISCREPENCY FOUND FOR HH SIZE 70T **70ST** RECORDS INDICATE 24"x36"x24" FIELD VERIFIED SIZE OF 30"x60"x30" OUTSIDE PLANT CONSTRUCTION
TITLE: FIBER OPTIC CABLE ROUTE POTHOLE UTILITIES -\$ 8 -RESTORE SIDEWALK-SHEET SHEET CSAH 61 (HEMLOCK LN N) 2 2 MATCH C/L of C DATE: 9/30/24 DESIGNER: EFH DRAWN BY: MI-TECH CONTRACTOR WILL HAVE ONLY ONE REVISIONS WORK ZONE ACTIVE AT A TIME. DESCRIPTION CONST PACK (1) 2" SDR-11 HDPE # 88B - ALTERNATE PEDESTRIAN ROUTE CROSSWALK CLOSURES AND PEDESTRIAN DETOURS PULL 432F CABLE IN NEW DUCT AVERAGE AREA LENGTH OF DETOUR 2600' 앜 DETOUR PEDESTRIANS TO WEST SIDE OF HEMLOCK FROM C WEST EAGLE LAKE DR TO 73RD AVE N. **EXPECTED DURATION LESS THAN 3 DAYS** 33 - RIGHT TURN LANE CLOSURE 7000 # 42 - RIGHT LANE CLOSURE IULIT-LANE UNDIVIDED ROAD (1) 2" SDR-11 HDPE SCALE AVERAGE AREA 10' X 280' 12F CABLE IN VZW DUCT OSTED SPEED 45 MPH HORIZONTAL: 1"=50' VERAGE AREA 10' X 100' 앜 = 600' G = 50' 3 = 425' L = 600' A = 600' G = 50' VERTICAL: 1"=50' EXPECTED DURATION LESS THAN 3 DAYS C XPECTED DURATION LESS THAN 3 DAYS 앜 TO MP SHEET TCP-1 OF 10 FILE: MAPLEGROVE_HEMLOCK-73RD

THE SUBSURFACE UTILITY INFORMATION IN THIS PLAN IS UTILITY QUALITY LEVEL D. THIS UTILITY QUALITY LEVEL WAS DETERMINED ACCORDING TO THE GUIDELINES OF CI/ASCE 38-02, ENTITLED STANDARD GUIDELINES FOR THE COLLECTION AND DEPICTION OF EXISTING SUBSURFACE UTILITY DATA. IT SHALL BE THE CONTRACTORS RESPONSIBILITY TO UTILIZE THE GOPHER STATE ONE CALL EXCAVATION NOTICE SYSTEM REQUIRED MN STATUTE, CHAPTER 216D FOR ALL UNDERGROUND UTILITY LOCATIONS. PROJECT: 095295 IEMLOCK LN - 73RD AVE TO 70TH PL MAPLE GROVE, MN φ 앜 449131 408230 442613 445312 408055 444398 ېٰ**S** ، 408434 407681 Ч POTHOLE UTILITIES ST **RESTORE SIDEWALK** φ POTHOLE UTILITIES OUTSIDE PLANT CONSTRUCTION
TITLE: FIBER OPTIC CABLE ROUTE POTHOLE UTILITIES \$(+, \$ **RESTORE SOD** CSAH 61 (HEMLOCK LN N) SHEET SHEET 5 으 MATCH. DATE: 9/30/24 PLACE 30"x60"x30" HH DESIGNER: EFH U-FOC-432 PLACE 100' SLACK COIL - 432F **DIRECTIONAL BORE 48" DEPTH** DRAWN BY: MI-TECH PLACE LOCATE STATION IN HH ONAL BORE 48" DEPTH CONTRACTOR WILL HAVE ONLY ONE (1) 2" SDR-11 HDPE SDR-11 HDPE PLACE GROUND ROD **REVISIONS** WORK ZONE ACTIVE AT A TIME. PULL 432F CABLE IN NEW DUCT 432F CABLE IN NEW DUCT DESCRIPTION POTHOLE UTILITIES -CONST PACK # 88B - ALTERNATE PEDESTRIAN ROUTE 2 ° **RESTORE ASPHALT** 쌓 CROSSWALK CLOSURES AND PEDESTRIAN DETOURS AVERAGE AREA LENGTH OF DETOUR 2600' DETOUR PEDESTRIANS TO WEST SIDE OF HEMLOCK FROM WEST EAGLE LAKE DR TO 73RD AVE N. **EXPECTED DURATION LESS THAN 3 DAYS** 7200 # 42 - RIGHT LANE CLOSURE IULIT-LANE UNDIVIDED ROAD SCALE HORIZONTAL: 1"=50' VERAGE AREA 10' X 100' 7180 = 425' L = 600' A = 600' G = 50' VERTICAL: 1"=50' XPECTED DURATION LESS THAN 3 DAYS TO MP SHEET TCP-2 OF 10 FILE: MAPLEGROVE_HEMLOCK-73RD

THE SUBSURFACE UTILITY INFORMATION IN THIS PLAN IS UTILITY QUALITY LEVEL D. THIS UTILITY QUALITY LEVEL WAS DETERMINED ACCORDING TO THE GUIDELINES OF CI/ASCE 38-02, ENTITLED STANDARD GUIDELINES FOR THE COLLECTION AND DEPICTION OF EXISTING SUBSURFACE UTILITY DATA. IT SHALL BE THE CONTRACTORS RESPONSIBILITY TO UTILIZE THE GOPHER STATE ONE CALL EXCAVATION NOTICE SYSTEM REQUIRED MN STATUTE, CHAPTER 216D FOR ALL UNDERGROUND UTILITY LOCATIONS.



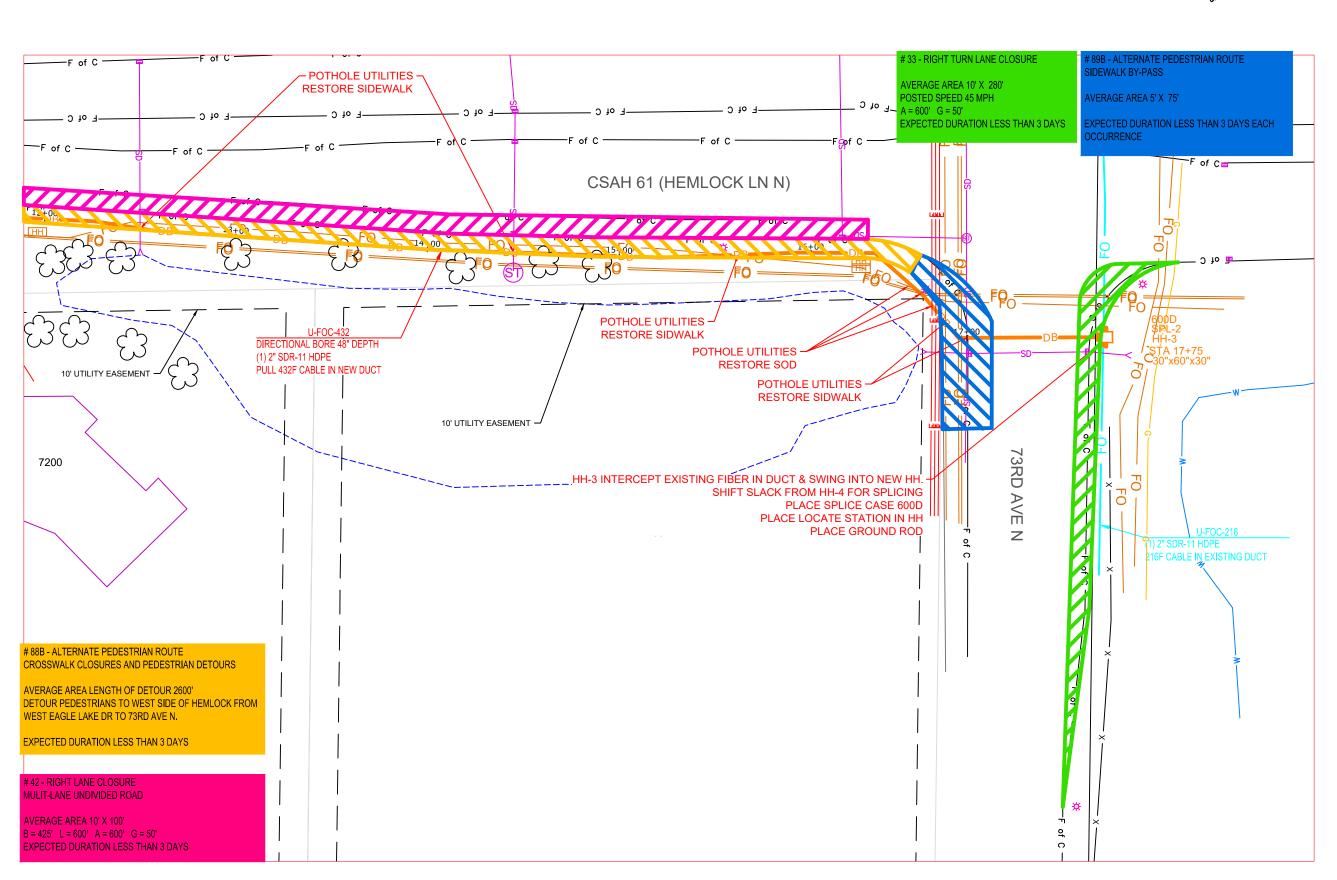



PROJECT: 095295

IEMLOCK LN - 73RD AVE TO 70TH PL

MAPLE GROVE, MN

| MAPLE GROVE, MN | | | | |
|--|----------------------------|--------------------------------|--|--|
| CLARIFICATION N | 0. | QUA | NTI | |
| | | | | |
| | | | | |
| MCImetro ACCESS TRANSMISSION SERVICES, LLC | OUTSIDE PLANT CONSTRUCTION | TITLE: FIBER OPTIC CABLE ROUTE | NED - GOLDEN VALLEY NORTH FAILURE DOMAIN | |
| DATE: 9/30/24 DESIGNER: EF | | | | |
| DESIGNER: EF | | -CH | | |
| DRAWN BY: MI-TECH REVISIONS | | | | |
| KENIZIONZ | | | | |

| ATE | DESCRIPTION | INITIAL |
|-------|-------------|---------|
| 10/24 | CONST PACK | SJH |
| | | |
| | | |
| | | |
| | | |
| | | |
| | | |

SCALE HORIZONTAL: 1"=50'

VERTICAL: 1"=50' TO MP

SHEET TCP-3 OF 10

FILE: MAPLEGROVE_HEMLOCK-73RD