

SITE NAME: PORTILLO'S

CASCADE ID: MS90XSU24-N MAPLE GROVE, MINNESOTA CONSTRUCTION DRAWINGS

SITE LOCATION MAPS

.50

SITE LOCATION

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ES

10

NORTH

SHEET INDEX

TITLE SHEET

GENERAL SPECIFICATIONS

SHEET TITLE

NO.:

G-001

G-002

8

DIRECTORY

ENGINEERING COMPANY: EDGE CONSULTING ENGINEERS, INC. 624 WATER STREET PRAIRIE DU SAC, WI 53578 PROJECT MANAGER: MICHAEL MLINER PROJECT ENGINEER: MICHAEL MUEHRER PHONE: 608.644.1449 FAX: 608.644.1549

ZAYO 5005 CHESHIRE PARKWAY SUITE 1 PLYMOUTH, MN 55446 CONTACT: DAVID BUSHAW PHONE: 952.230.9662

SITE ACQUISITION: BUELL CONSULTING, INC. 1360 ENERGY PARK DRIVE SUITE 210 ST. PAUL, MN 55108 CONTACT: SHELLEY TRAMPETTI PHONE: 651.895.6823

SURVEYOR: EGAN, FIELD & NOWAK, INC. 1229 TYLER STREET N.E. MINNEAPOLIS, MN 55413 CONTACT: KENNETH G. FAUCHER PHONE: 612.466.3363

POWER PROVIDER: WRIGHT - HENNEPIN COOPERATIVE ELECTRIC ASSOCIATION (WHE) 6800 ELECTRIC DRIVE, P.O. BOX 330 ROCKFORD, MN 55373 CONTACT: RYAN DANIELS EMAIL: rdaniels@whe.org PHONE: 612.719.9811

PROJECT INFO

CASCADE ID: MS90XSU24-N

SITE COORDINATES LAT (NAD83): 45°-05'-38.43° LONG (NAD83): -93°-26'-07.25° LAT, LONG: 45.09400, -93.43533 GROUND ELEVATION (NAVD88): 921'

INTERSECTION: ELM CREEK BLVD N. AND HEMLOCK LANE N.

CITY: MAPLE GROVE

> STATE: MINNESOTA

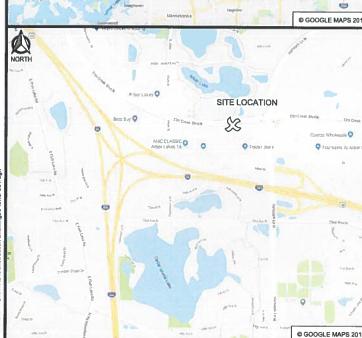
ZIP: 55369

County: Hennepin

JURISDICTION: MAPLE GROVE

PROPERTY OWNER: CITY OF MAPLE GROVE PUBLIC RIGHT-OF-WAY

POLE OWNER: CITY OF MAPLE GROVE



G-003 GENERAL SPECIFICATIONS G-004 GENERAL SPECIFICATIONS SURVEY * CLIENT: C-101 SITE PLAN T-201 SITE ELEVATION T-501 ANTENNA DETAILS T-502 EQUIPMENT SPECIFICATIONS T-503 EQUIPMENT MOUNTING E-101 UTILITY PLAN E-501 GROUNDING DETAILS E-502 UTILITY DETAILS E-503 METER UTILITY DETAILS D-501 TRAFFIC CONTROL PLAN D-502 PEDESTRIAN SAFETY PLAN * COMPLETED BY OTHERS POLE TO BE PAINTED DARK BRONZE PER CITY'S REQUEST CONTRACTOR SHALL VERIFY ALL PLANS AND EXISTING DIMENSIONS/CONDITIONS ON SITE. IMMEDIATELY NOTIFY ENGINEER OF ANY DISCREPANCIES PRIOR TO PERFORMING ANY WORK OR BE RESPONSIBLE FOR THE SAME **STRUCTURAL ANALYSIS** STRUCTURAL ANALYSIS BY: EDGE CONSULTING ENGINEERS, INC. REPORT #: 17258 DATED: 4/20/2018

CONTRACTOR TO REVIEW STRUCTURAL REPORT IN ITS ENTIRETY. ANY DISCREPANCIES OR DISAGREEMENTS BETWEEN THE REPORT AND

ALL WORK SHALL COMPLY WITH THE FOLLOWING APPLICABLE CODES:

AASHTO LRFD SPECIFICATIONS FOR STRUCTURAL SUPPORTS FOR HIGHWAY SIGNS, LUMINAIRES, AND TRAFFIC SIGNALS, 1ST EDITION

IN THE EVENT OF CONFLICT, THE MOST RESTRICTIVE CODE SHALL PREVAIL

THESE PLANS SHOULD BE RESOLVED PRIOR TO CONSTRUCTION.



TO OBTAIN LOCATION OF PARTICIPANTS' UNDERGROUND FACILITIES BEFORE YOU DIG IN MINNESOTA, CALL GOPHER STATE ONE CALL

> TOLL FREE: 1-800-252-1166 FAX A LOCATE: 1-800-236-4967

MN STATUTE REQUIRES MIN. OF 48 HOURS NOTICE BEFORE YOU EXCAVATE





		6 PRA 8 W NT: 5005 PL	24 W/ IRIE I 608.6 WW.er	Edgee Bengheers, Inc. ATER STREET DU SAC, WI SASTB M.1489 VOICE M.159 FAX deconsult.com Beconsult.co
SCOPE OF WORK				
END USER PROPOSED TO INSTALL EQUIPMENT ON A PROPOSED 40' STEEL POLE WITH LUMINAIRE WITHIN THE PUBLIC RIGHT-OF-WAY. PROPOSED EQUIPMENT: (1) PANEL ANTENNA (1) PANEL ANTENNA (1) GPS ANTENNA (1) RADIO (1) A/C POWER DISTRIBUTION PANEL (1) DISCONNECT (1) ELECTRIC METER CONDUIT AND WEATHERHEADS AS REQUIRED				ME: PORTILLO'S ID: MS90XSU24-N OVE, MINNESOTA
APPLICABLE CODES				E GR
ALL WORK SHALL COMPLY WITH THE FOLLOWING APPLICABLE CODES: - 2012 INTERNATIONAL BUILDING CODE - 2014 NATIONAL ELECTRIC CODE IN THE EVENT OF CONFLICT, THE MOST RESTRICTIVE CODE SHALL PREVAIL				SITI CASC MAPL
GENERAL NOTES				
THE FACILITY IS UNMANNED AND NOT FOR HUMAN HABITATION. A TECHNICIAN WILL VISIT THE SITE AS REQUIRED FOR ROUTINE MAINTENANCE. THE PROJECT WILL NOT RESULT IN ANY SIGNIFICANT DISTURBANCE OR HAVE AN EFFECT ON DRAINAGE.	SHEET TITLE:			DESCRIPTION: REV. A
SANITARY SEWER SERVICE, OR POTABLE WATER. TRASH DISPOSAL IS REQUIRED AND NO COMMERCIAL SIGNAGE IS PROPOSED.	SUBM INT. NAT	DAT DAT	re:	
SANITARY SEWER SERVICE, OR POTABLE WATER. TRASH DISPOSAL IS REQUIRED AND NO COMMERCIAL SIGNAGE IS PROPOSED.	INT.	DA1 04/19	FE: 8/18 4/18	REV. 0 REV. 1
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SANITARY SEWER SERVICE, OR POTABLE WATER. TRASH DISPOSAL IS REQUIRED AND NO COMMERCIAL SIGNAGE IS PROPOSED. I HEREBY CERTIFY THAT THIS PLAN SET WAS PREPARED BY ME OR UNDER MY DIRECT SUPERVISION OTHER THAN THE EXCEPTIONS NOTED IN THE SHEET INDEX, AND THAT I AM A DULY LICENSED PROFESSIONAL ENGINEER UNDER THE LAWS OF THE STATE OF MINNESOTA.	INT. NAT NAT NAT	DA1 04/18 05/24 10/17	FE: 8/18 4/18	REV. 1
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GENERAL CONSTRUCTION NOTES:

- ALL WORK SHALL CONFORM TO THE REQUIREMENTS OF THE LOCAL BUILDING CODE. THE LATEST ADOPTED EDITION AND ALL OTHER APPLICABLE CODES AND ORDINANCES
- CONTRACTOR SHALL CONSTRUCT SITE IN ACCORDANCE WITH THESE DRAWINGS AND 2. LATEST ZAYO CONSTRUCTION STANDARDS. THE SPECIFICATION IS THE RULING DOCUMENT AND ANY DISCREPANCIES BETWEEN THE SPECIFICATION AND THE CONSTRUCTION DRAWINGS SHALL BE BROUGHT TO THE ATTENTION OF THE ARCHITECT/ENGINEER OR ZAYO CM PRIOR TO THE COMMENCEMENT OF WORK.
- CONTRACTOR SHALL VISIT THE JOB SITE AND SHALL FAMILIARIZE THEMSELVES WITH ALL 3. CONDITIONS AFFECTING THE PROPOSED WORK AND SHALL MAKE PROVISIONS AS TO THE COST THEREOF. CONTRACTOR SHALL BE RESPONSIBLE FOR FAMILIARIZING THEMSELVES WITH ALL CONTRACT DOCUMENTS, FIELD CONDITIONS AND DIMENSIONS AND CONFIRMING THAT THE WORK MAY BE ACCOMPLISHED, AS SHOWN, PRIOR TO PROCEEDING WITH CONSTRUCTION. ANY DISCREPANCIES SHALL BE BROUGHT TO THE ATTENTION OF THE ARCHITECT/ENGINEER OR ZAYO CM PRIOR TO THE COMMENCEMENT OF WORK. NO COMPENSATION WILL BE AWARDED BASED ON CLAIM OF LACK OF KNOWLEDGE OF FIELD CONDITIONS.
- IT IS NOT THE INTENT OF THESE PLANS TO SHOW EVERY MINOR DETAIL OF 4. CONSTRUCTION. CONTRACTOR IS REQUIRED TO FURNISH AND INSTALL ANY/ALL ITEMS FOR A COMPLETE AND FULL FUNCTIONAL SYSTEM SUBJECT ONLY TO OWNER-SUPPLIED ITEMS. CONTRACTOR SHALL PROVIDE ANY/ALL REQUIREMENTS FOR THE EQUIPMENT TO BE PLACED IN PROPER WORKING ORDER
- PLANS ARE NOT TO BE SCALED. THESE PLANS ARE INTENDED TO BE A DIAGRAMMATIC 5. OUTLINE ONLY UNLESS OTHERWISE NOTED. THE WORK SHALL INCLUDE FURNISHING MATERIALS, EQUIPMENT AND APPURTENANCES, AND LABOR NECESSARY TO EFFECT ALL INSTALLATIONS AS INDICATED ON THE DRAWINGS. OWNER PROVIDED AND CONTRACTOR INSTALLED MATERIALS WILL INCLUDE THE FOLLOWING, UNLESS NOTED OTHERWISE:
 - A) TRANSMITTER
 - B) UHF ANTENNA AND MOUNTING BRACKETS, GPS ANTENNAS AND KU ANTENNAS
 - C) UHF COAX AND HANGERS
 - D) INTEGRATED LOAD CENTER
- DIMENSIONS SHOWN ARE TO FINISH SURFACES UNLESS OTHERWISE NOTED. SPACING 6. BETWEEN EQUIPMENT IS REQUIRED CLEARANCE. THEREFORE, IT IS CRITICAL TO FIELD VERIFY DIMENSIONS. SHOULD THERE BE ANY QUESTIONS REGARDING THE CONTRACT DOCUMENTS, EXISTING CONDITIONS AND/OR DESIGN INTENT, THE CONTRACTOR SHALL BE RESPONSIBLE FOR REPORTING ANY DISCREPANCIES TO THE ATTENTION OF THE ZAYO CM, IN WRITING, PRIOR TO THE COMMENCEMENT OF WORK.
- DETAILS PROVIDED ARE FOR THE PURPOSE OF SHOWING DESIGN INTENT. MODIFICATIONS 7. MAY BE REQUIRED TO SUIT JOB DIMENSIONS OR SITE CONDITIONS, AND SUCH MODIFICATIONS SHALL BE INCLUDED AS PART OF THE WORK.
- 8. CONTRACTOR SHALL PAY FOR APPLICABLE PERMITS, FEES, INSPECTIONS AND TESTING. CONTRACTOR IS TO OBTAIN PERMITS AND APPROVED SUBMITTALS PRIOR TO ORDERING MATERIALS AND THE COMMENCEMENT OF WORK.
- THE TERM "PROVIDE" USED IN CONSTRUCTION DOCUMENTS AND SPECIFICATIONS, 9. INDICATES THAT THE CONTRACTOR SHALL FURNISH AND INSTALL.
- 10. CONTRACTOR SHALL RECEIVE CLARIFICATION IN WRITING, AND SHALL RECEIVE IN WRITING AUTHORIZATION TO PROCEED BEFORE STARTING WORK ON ANY ITEMS NOT CLEARLY DEFINED OR IDENTIFIED BY THE CONTRACT DOCUMENTS.
- 11. CONTRACTOR SHALL SUPERVISE AND DIRECT THE WORK USING ACCEPTED INDUSTRY-STANDARD SKILLS AND ATTENTION. CONTRACTOR SHALL BE SOLELY RESPONSIBLE FOR CONSTRUCTION MEANS, METHODS, TECHNIQUES, SEQUENCES AND PROCEDURES AND FOR COORDINATING ALL PORTIONS OF THE WORK UNDER CONTRACT, UNLESS OTHERWISE NOTED.
- CONTRACTOR SHALL BE RESPONSIBLE FOR THE SAFETY OF THE WORK AREA AD JACENT 12. AREAS AND BUILDING OCCUPANTS THAT ARE LIKELY TO BE AFFECTED BY THE WORK UNDER THIS CONTRACT. WORK SHALL CONFORM TO ALL OSHA REQUIREMENTS.
- 13. CONTRACTOR SHALL COORDINATE THEIR WORK WITH THE ZAYO CM AND SCHEDULE THEIR ACTIVITIES AND WORKING HOURS IN ACCORDANCE WITH THE REQUIREMENTS
- CONTRACTOR SHALL BE RESPONSIBLE FOR COORDINATING THEIR WORK WITH THE WORK 14. OF OTHERS AS IT MAY RELATE TO RADIO EQUIPMENT. ANTENNAS AND ANY OTHER PORTIONS OF THE WORK
- 15. CONTRACTOR SHALL INSTALL ALL EQUIPMENT AND MATERIALS IN ACCORDANCE WITH MANUFACTURERS RECOMMENDATIONS UNLESS SPECIFICALLY OTHERWISE INDICATED OR WHERE LOCAL CODES OR REGULATIONS TAKE PRECEDENCE.
- 16. CONTRACTOR SHALL MAKE NECESSARY PROVISIONS TO PROTECT EXISTING SURFACES, EQUIPMENT, IMPROVEMENTS, PIPING ETC. AND IMMEDIATE REPAIR, TO NEW CONDITION, ANY DAMAGE THAT OCCURS DURING CONSTRUCTION AT THE SOLE COST OF THE CONTRACTOR

- 17. IN DRILLING HOLES, OR CORING, INTO CONCRETE WHETHER FOR FASTENING OR ANCHORING PURPOSES, OR PENETRATIONS THROUGH THE FLOOR FOR CONDUIT RUNS, PIPE RUNS, ETC., MUST BE CLEARLY UNDERSTOOD THAT REINFORCING STEEL SHALL NOT BE DRILLED INTO, CUT OR DAMAGED UNDER ANY CIRCUMSTANCES (UNLESS NOTED OTHERWISE). LOCATIONS OF REINFORCING STEEL ARE NOT DEFINITELY KNOWN AND THEREFORE MUST BE LOCATED BY THE CONTRACTOR USING APPROPRIATE METHODS AND EQUIPMENT PRIOR TO ANY DRILLING OR CORING OPERATIONS IN EXISTING CONCRETE
- 18 CONTRACTOR SHALL REPAIR, TO NEW CONDITION, ALL EXISTING WALL SURFACES DAMAGED DURING CONSTRUCTION SUCH THAT THEY MATCH AND BLEND IN WITH ADJACENT SURFACES.
- CONTRACTOR SHALL SEAL PENETRATIONS THROUGH FIRE RATED ASSEMBLIES OR 19. MATERIALS WITH U.L. LISTED AND FIRE CODE APPROVED MATERIALS AND SYSTEMS THAT MEET OR EXCEED THE RATING OF THE ASSEMBLY IN WHICH THE NEW PENETRATION IS PLACED
- CONTRACTOR SHALL KEEP CONTRACT AREA CLEAN, HAZARD FREE, AND DISPOSE OF ALL 20. DIRT, DEBRIS, AND RUBBISH. EQUIPMENT NOT SPECIFIED AS REMAINING ON THE PROPERTY OF THE OWNER SHALL BE REMOVED. LEAVE PREMISES IN CLEAN CONDITION AND FREE FROM PAINT SPOTS DUST OR SMUDGES OF ANY NATURE. CONTRACTOR SHALL BE RESPONSIBLE FOR MAINTAINING ALL ITEMS UNTIL COMPLETION OF CONSTRUCTION.
- 21. MINIMUM BEND RADIUS OF ANTENNA CABLES SHALL BE IN ACCORDANCE WITH CABLE MANUFACTURERS RECOMMENDATIONS.
- CONTRACTOR SHALL MINIMIZE DISTURBANCE TO EXISTING SITE DURING CONSTRUCTION. 22. FROSION CONTROL MEASURES, IF REQUIRED DURING CONSTRUCTION SHALL BE IN CONFORMANCE WITH JURISDICTIONAL OR STATE AND LOCAL GUIDELINES FOR EROSION AND SEDIMENT CONTROL AND COORDINATED WITH LOCAL REGULATORY AUTHORITIES. CONTRACTOR SHALL BE RESPONSIBLE FOR MAINTENANCE OF ANY EROSION CONTROL MEASURES, RECORD-KEEPING, MONITORING, AND REPORTING TO THE OWNER AND REGULATORY AUTHORITIES.
- ALL CONSTRUCTION WORK IS TO ADHERE TO APPLICANT'S INTEGRATED CONSTRUCTION 23. STANDARDS UNLESS STATE OR LOCAL CODE IS MORE STRINGENT
- THE INTENT OF THE PLANS AND SPECIFICATIONS IS TO PERFORM THE CONSTRUCTION IN 24. ACCORDANCE PER STATE BUILDING STANDARDS CODE AND STATE CODE OF REGULATIONS. SHOULD ANY CONDITIONS DEVELOP NOT COVERED BY THE APPROVED PLANS AND SPECIFICATIONS WHEREIN THE FINISHED WORK WILL NOT COMPLY PER STATE CODE OF REGULATIONS, A SCOPE OF WORK DETAILING AND SPECIFYING THE REQUIRED WORK SHALL BE SUBMITTED TO AND APPROVED BY THE JURISDICTION BEFORE PROCEEDING WITH THE WORK. A CHANGE ORDER FOR THAT SCOPE SHALL BE SUBMITTED TO THE ZAYO CM PRIOR TO PROCEEDING WITH THE WORK.
- ADEQUATE AND REQUIRED LIABILITY INSURANCE SHALL BE PROVIDED BY THE 25. CONTRACTOR FOR PROTECTION AGAINST PUBLIC LOSS AND ANY/ALL PROPERTY DAMAGE FOR THE DURATION OF WORK
- 26. CONTRACTOR SHALL GUARANTEE ANY/ALL MATERIALS AND WORK FREE FROM DEFECTS FOR A PERIOD OF NOT LESS THAN ONE YEAR FROM DATE OF ACCEPTANCE. ANY CORRECTIVE WORK SHALL BE COMPLETED AT THE SOLE COST OF THE CONTRACTOR

ELECTRICAL NOTES:

- ELECTRICAL CONTRACTOR SHALL SUPPLY AND INSTALL ANY/ALL ELECTRICAL WORK INDICATED. ANY/ALL CONSTRUCTION SHALL BE IN ACCORDANCE W/DRAWINGS AND ANY/ALL APPLICABLE SPECIFICATIONS. IF ANY PROBLEMS ARE ENCOUNTERED BY COMPLYING WITH THESE REQUIREMENTS, CONTRACTOR SHALL NOTIFY ZAYO CM AS SOON AS POSSIBLE, AFTER THE DISCOVERY OF THE PROBLEMS, AND SHALL NOT PROCEED WITH THAT PORTION OF WORK, UNTIL THE ZAYO CM HAS DIRECTED THE CORRECTIVE ACTIONS TO BE TAKEN
- ELECTRICAL CONTRACTOR SHALL VISIT THE JOB SITE AND FAMILIARIZE THEMSELVES WITH ANY/ALL CONDITIONS AFFECTING ELECTRICAL AND COMMUNICATION INSTALLATION AND MAKE PROVISIONS AS TO THE COST THEREOF. ALL EXISTING CONDITIONS OF ELECTRICAL EQUIP., ETC., THAT ARE PART OF THE FINAL SYSTEM, SHALL BE VERIFIED BY THE CONTRACTOR, PRIOR TO THE SUBMITTING OF THEIR BID. FAILURE TO COMPLY WITH THIS PARAGRAPH WILL IN NO WAY RELIEVE CONTRACTOR OF PERFORMING ALL WORK NECESSARY FOR A COMPLETE AND WORKING SYSTEM.

- 3. LIMITED TO:
 - A) UL UNDERWRITERS LABORATORIES
 - B) NEC NATIONAL ELECTRICAL CODE
- 5. WRITTEN PERMISSION OF THE OWNER.
- 6. WORK
- 7. UNLESS OTHERWISE NOTED.
- 8. CLASSIFIED AREAS.
- 9. TO BE PLACED IN PROPER WORKING ORDER.
- REQUIRED BY SPECIFICATIONS. SET FORTH BY APPLICANT
- CONTRACTOR.
- THE PROGRESS OF CONSTRUCTION.
- 13 THEREIN
- 15.
- EXCEED THE REQUIREMENTS OF THE NEC, NEMA AND IECE.
- BY THE ZAYO CM PRIOR TO INSTALLATION.
- ACCEPTANCE
- 19 FLECTRICAL CONTRACTOR

NSULTAN 💦 Edge ALL WORK SHALL BE PERFORMED IN ACCORDANCE WITH THE LATEST EDITION OF THE NEC, ALL CODES AND ORDINANCES OF THE LOCAL JURISDICTION, AND POWER & Iting Engineers, TELEPHONE COMPANIES HAVING JURISDICTION AND SHALL INCLUDE BUT ARE NOT BE 624 WATER STREET PRAIRIE DU SAC, WI 53578 608.644.1449 VOICE 608.644.1549 FAX www.edgeconsult.com C) NEMA - NATIONAL ELECTRICAL MANUFACTURERS ASSOC. D) OSHA - OCCUPATIONAL SAFETY AND HEALTH ACT 5005 CHESHIRE PARKWA SUITE 1 PLYMOUTH, MN 55446 952.230.9662 VOICE E) SBC - STANDARD BUILDING CODE www.zavo.com F) NEPA - NATIONAL FIRE PROTECTION AGENCY G) ANSI - AMERICAN NATIONAL STANDARDS INSTITUTE H) IEEE - INSTITUTE OF ELECTRICAL AND ELECTRONICS ENGINEERS I) ASTM - AMERICAN SOCIETY FOR TESTING MATERIALS 4. REFER TO SITE PLANS AND ELEVATIONS FOR EXACT LOCATIONS OF ALL EQUIPMENT, AND CONFIRM WITH ZAYO CM ANY SIZES AND LOCATIONS WHEN NEEDED EXISTING SERVICES: CONTRACTOR SHALL NOT INTERRUPT EXISTING SERVICES WITHOUT CONTRACTOR SHALL CONFIRM WITH LOCAL UTILITY COMPANY ANY/ALL REQUIREMENTS **PECIFICATIONS** SUCH AS THE: LUG SIZE RESTRICTIONS, CONDUIT ENTRY, SIZE OF TRANSFORMERS, SCHEDULED DOWNTIME FOR THE OWNERS' CONFIRMATION, ETC... ANY/ALL CONFLICTS SHALL BE BROUGHT TO THE ATTENTION OF THE ZAYO CM, PRIOR TO BEGINNING ANY **INERAL SPECIFICATIC** SITE NAME: PORTILLO'S CASCADE ID: MS90XSU24-N MAPLE GROVE, MINNESOTA z٩ MINIMUM WIRE SIZE SHALL BE #12 AWG, NOT INCLUDING CONTROL WIRING, UNLESS NOTED OTHERWISE, ALL CONDUCTORS SHALL BE COPPER WITH THWN INSULATION. OUTLET BOXES SHALL BE PRESSED STEEL IN DRY LOCATIONS, CAST ALLOY WITH THREADED HUBS IN WET/DAMP LOCATIONS AND SPECIAL ENCLOSURES FOR OTHER IT IS NOT THE INTENT OF THESE PLANS TO SHOW EVERY MINOR DETAIL OF THE CONSTRUCTION. CONTRACTOR IS EXPECTED TO FURNISH AND INSTALL ALL ITEMS FOR A COMPLETE ELECTRICAL SYSTEM AND PROVIDE ALL REQUIREMENTS FOR THE EQUIPMENT 10. ELECTRICAL SYSTEM SHALL BE AS COMPLETELY AND EFFECTIVELY GROUNDED, AS GEN 11. ALL WORK SHALL BE PERFORMED BY A LICENSED ELECTRICAL CONTRACTOR IN A FIRST CLASS, WORKMANLIKE MANNER. THE COMPLETED SYSTEM SHALL BE FULLY FUNCTIONAL AND SHALL BE APPROVED BY THE ZAYO CM AND LOCAL JURISDICTION. ANY DEFICIENCIES SHALL BE CORRECTED BY AN ELECTRICAL CONTRACTOR AT THE SOLE COST OF THE 12. ALL WORK SHALL BE COORDINATED WITH OTHER TRADES TO AVOID INTERFERENCE WITH THE CORRECTION OF ANY DEFECTS SHALL BE COMPLETED BY THE CONTRACTOR WITHOUT ANY ADDITIONAL CHARGE AND SHALL INCLUDE THE REPLACEMENT OR THE REPAIR OF ANY OTHER PHASE OF THE INSTALLATION, WHICH MAY HAVE BEEN DAMAGED 14. CONTRACTOR SHALL PROVIDE AND INSTALL CONDUIT, CONDUCTORS, PULL WIRES, BOXES, COVER PLATES AND DEVICES FOR ALL OUTLETS AS INDICATED. DITCHING AND BACK FILL: CONTRACTOR SHALL PROVIDE FOR ALL UNDERGROUND INSTALLED CONDUIT AND/OR CABLES INCLUDING EXCAVATION AND BACKFILLING AND UBMITTAL COMPACTION. REFER TO NOTES AND REQUIREMENTS 'EXCAVATION, AND BACKFILLING. NT. DATE: DESCRIPTION: NAT 04/19/18 REV. A 16. MATERIALS, PRODUCTS AND EQUIPMENT, INCLUDING ALL COMPONENTS THEREOF, SHALL BE NEW AND SHALL APPEAR ON THE LIST OF U.L. APPROVED ITEMS AND SHALL MEET OR IAT 05/24/18 REV. 0 NAT 10/17/18 REV. 1 17. CONTRACTOR SHALL SUBMIT SHOP DRAWINGS OR MANUFACTURER'S CATALOG INFORMATION OF ANY/ALL EQUIPMENT AND ALL OTHER ELECTRICAL ITEMS FOR APPROVAL 18. ANY CUTTING OR PATCHING DEEMED NECESSARY FOR ELECTRICAL WORK IS THE ELECTRICAL CONTRACTORS RESPONSIBILITY AND SHALL BE INCLUDED IN THE COST FOR WORK AND PERFORMED TO THE SATISFACTION OF THE ZAYO CM UPON FINAL HECKE MRM 10/17/2018 THE ELECTRICAL CONTRACTOR SHALL LABEL ALL PANELS WITH ONLY TYPEWRITTEN DIRECTORIES. ALL ELECTRICAL WIRING SHALL BE THE RESPONSIBILITY OF THE 17258 SET FINAL CDs

G-002

SHEET

ELECTRICAL NOTES (CONTINUED):

- DISCONNECT SWITCHES SHALL BE UL-RATED, H.P. RATED HEAVY-DUTY, QUICK-MAKE AND QUICK-BREAK ENCLOSURES, AS REQUIRED BY EXPOSURE TYPE.
- ALL CONNECTIONS SHALL BE MADE WITH A PROTECTIVE COATING OF AN ANTI-OXIDE 21. COMPOUND KNOWN AS "NO-OXIDE A" BY DEARBORNE CHEMICAL CO. COAT ALL WIRE SURFACES BEFORE CONNECTING. EXPOSED COPPER SURFACES, INCLUDING GROUND BARS, SHALL BE TREATED - NO SUBSTITUTIONS.
- 22. RACEWAYS: CONDUIT SHALL BE SCHEDULE 80 PVC MEETING OR EXCEEDING NEMA TC2 -1990. CONTRACTOR SHALL PLUG AND CAP EACH END OF SPARE AND EMPTY CONDUITS AND PROVIDE TWO SEPARATE PULL STRINGS - 200 LBS TEST POLYETHYLENE CORD. ALL CONDUIT BENDS SHALL BE A MINIMUM OF 2 FT. RADIUS. RGS CONDUITS WHEN SPECIFIED, SHALL MEET UL-6 FOR GALVANIZED STEEL. ALL FITTINGS SHALL BE SUITABLE FOR USE WITH THREADED RIGID CONDUIT. COAT ALL THREADS WITH 'BRITE ZINC' OR 'COLD GALV'.
- 23. SUPPORT OF ALL ELECTRICAL WORK SHALL BE AS REQUIRED BY NEC.
- CONDUCTORS: CONTRACTOR SHALL USE 98% CONDUCTIVITY COPPER WITH TYPE THWN 24. INSULATION, UNLESS OTHERWISE NOTED, 600 VOLT, COLOR CODED. USE SOLID CONDUCTORS FOR WIRE UP TO AND INCLUDING NO. 8 AWG. USE STRANDED CONDUCTORS FOR WIRE ABOVE NO. 8 AWG.
- 25. CONNECTORS FOR POWER CONDUCTORS: CONTRACTOR SHALL USE PRESSURE TYPE INSULATED TWIST-ON CONNECTORS FOR NO. 10 AWG AND SMALLER. USE SOLDERLESS MECHANICAL TERMINAL LUGS FOR NO 8 AWG AND LARGER
- SERVICE: AS SPECIFIED ON THE DRAWINGS. OWNER OR OWNER'S AGENT WILL APPLY FOR 26. POWER. ALL PROVISIONS FOR TEMPORARY POWER WILL BE OBTAINED BY THE CONTRACTOR
- 27. TELEPHONE OR FIBER SERVICE: CONTRACTOR SHALL PROVIDE EMPTY CONDUITS WITH PULL STRINGS AS INDICATED ON DRAWINGS.
- 28. ELECTRICAL AND TELCO/FIBER RACEWAYS TO BE BURIED A MINIMUM DEPTH OF 30", UNLESS OTHERWISE NOTED.
- CONTRACTOR SHALL PLACE 6" WIDE DETECTABLE WARNING TAPE AT A DEPTH OF 6" 29. BELOW GROUND AND DIRECTLY ABOVE ELECTRICAL AND TELCO SERVICE CONDUITS. CAUTIONS TAPE TO READ "CAUTION BURIED ELECTRIC" OR "BURIED TELECOM".
- 30. ALL BOLTS SHALL BE 3-16 STAINLESS STEEL

GROUNDING NOTES:

- 1. ALL HARDWARE SHALL BE 3-16 STAINLESS STEEL, INCLUDING LOCK WASHERS. COAT ALL SURFACES WITH AN ANTI-OXIDANT COMPOUND, AS SPECIFIED, BEFORE MATING. ALL HARDWARE SHALL BE STAINLESS STEEL 3/8 INCH DIAMETER OR SIZED TO MATCH COMPONENTS OR LOG SIZE.
- FOR GROUND BOND TO STEEL ONLY: INSERT A CADMIUM FLAT WASHER BETWEEN LUG 2. AND STEEL COAT ALL SURFACES WITH AN ANTI-OXIDANT COMPOUND BEFORE MATING
- ALL STEEL CONDUIT SHALL BE BONDED AT BOTH ENDS WITH GROUNDING BUSHING. 3.
- ALL ELECTRICAL AND GROUNDING AT THE POLE SITE SHALL COMPLY WITH THE NATIONAL ELECTRICAL CODE (NEC), NATIONAL FIRE PROTECTION ASSOCIATION (NFPA) 780 (LATEST EDITION) AND MANUFACTURER
- ALL DETAILS ARE SHOWN IN GENERAL TERMS. ACTUAL GROUNDING INSTALLATION AND 5. CONSTRUCTION MAY VARY DUE TO SITE SPECIFIC CONDITIONS.
- GROUND ALL ANTENNA BASES, FRAMES, CABLE RUNS, AND OTHER METALLIC COMPONENTS USING #6 GROUND WIRES. FOLLOW ANTENNA AND BTS MANUFACTURER'S PRACTICES FOR GROUNDING REQUIREMENTS.
- 7. ALL GROUND CONNECTIONS SHALL BE #6 AWG, UNLESS OTHERWISE NOTED. USE SOLID COPPER, BLACK JACKETED WIRE ON NON WOOD POLES AND SOLID TINNED COPPER, BARE (NO JACKET) WIRES ON WOOD POLES. BLACK WIRES WILL USE A SINGLE STRIPE OF GREEN ELECTRICAL TAPE WITHING 12" OF THE CONNECTION POINTS TO IDENTIFY AS GROUNDING
- NOTIFY ARCHITECT/ENGINEER IF THERE ARE ANY DIFFICULTIES INSTALLING GROUNDING 8. SYSTEM DUE TO SITE SOIL CONDITIONS.
- ALL HORIZONTALLY RUN GROUNDING CONDUCTORS SHALL BE INSTALLED A MINIMUM OF 30" BELOW GRADE/ 6" BELOW FROST-LINE IN TRENCH, UNLESS OTHERWISE NOTED. BACK FILL SHALL BE COMPACTED AS REQUIRED BY ARCHITECT/ENGINEER.
- ALL GROUND CONDUCTORS SHALL BE RUN AS STRAIGHT AND SHORT AS POSSIBLE. WITH 10. A MINIMUM 12" BENDING RADIUS NOT LESS THAN 90 DEGREES.
- 11. ACCEPTABLE CONNECTIONS FOR GROUNDING SYSTEM SHALL BE:

A. BURNDY, HY-GRADE U.L. LISTED CONNECTORS FOR OUTDOOR USE OR AS APPROVED BY APPLICANT PROJECT MANAGER.

- B. CADWELD, EXOTHERMIC WELDS (WELDED CONNECTIONS)
- C. ONE (1) OR (2) HOLES TINNED COPPER COMPRESSION (LONG BARREL) FITTINGS.

- 12. ALL CRIMPED CONNECTIONS SHALL HAVE EMBOSSED MANUFACTURER'S DIEMARK VISIBLE AT THE CRIMP (RESULTING FROM USE OF PROPER CRIMPING DEVICES) AND WEATHER-PROOFED WITH HEAT SHRINK
- 13. ALL CONNECTION HARDWARE SHALL BE TYPE 3-16 STAINLESS STEEL (NOT ATTRACTED TO MAGNETS).
- ELECTRICAL SERVICE EQUIPMENT GROUNDING SHALL COMPLY WITH NEC ARTICLE 250-82 14 AND SHALL BOND ALL EXISTING AND NEW GROUNDING ELECTRODES. NEW GROUNDING ELECTRODE SHALL INCLUDE BUT NOT LIMITED TO GROUND RODS.

TESTING AND EQUIPMENT TURN UP REQUIREMENTS:

- RF CABLE, DATA CABLE, RADIO EQUIPMENT AND BACK HAUL EQUIPMENT TESTING WILL COMPLY WITH CURRENT INDUSTRY STANDARDS AND OR THOSE STANDARDS OF THE EQUIPMENT MANUFACTURER OR PROVIDED TO THE CONTRACTOR PRIOR TO TESTING.
- CONTRACTOR WILL USE THE APPROPRIATE CALIBRATED TESTING FOURPMENT IN THE 2. TESTING OF RE CABLE, DATA CABLE, RADIO EQUIPMENT AND BACK HAUL EQUIPMENT THAT MEET INDUSTRY STANDARDS OF THE MANUFACTURER OR THOSE STANDARDS PROVIDED TO THE CONTRACTOR PRIOR TO TESTING.
- CONTRACTOR TO VERIFY AND RECORD ALL TEST RESULTS AND PROVIDE THESE RESULTS 3 WITHIN THE FINAL CLOSE OUT PACKAGE.
- ALL PERSONNEL INVOLVED IN THE TESTING OF RECABLE DATA CABLE RADIO FOURPMENT AND BACK HAUL EQUIPMENT WILL BE REQUIRED TO HAVE BEEN TRAINED AND OR CERTIFIED IN THE PROPER TESTING OF RF CABLE, DATA CABLE, RADIO EQUIPMENT AND BACK HAUL EQUIPMENT
- ALL TEST RESULTS SHALL BE TIME STAMPED, RECORDED AND PRESENTED PRIOR TO 5 ENERGIZING AND TURN UP OF ANY EQUIPMENT.
- GPS EQUIPMENT (WHEN REQUIRED) IS NOT TO BE TESTED OR ATTACHED TO ANY CABLING DURING TESTING, DOING SO WILL DAMAGE THE GPS UNIT
- PRIOR TO TESTING IF THE CONTRACTOR HAS ANY QUESTIONS ABOUT THE TESTING PROCEDURES THEY ARE TO CALL AND OBTAIN ASSISTANCE FROM A QUALIFIED DESIGNATED TESTING REPRESENTATIVE
- EQUIPMENT IS NOT TO BE ENERGIZED UNTIL ALL TESTING HAS BEEN COMPLETED, APPROVED AND THE APPROPRIATE AUTHORITY HAS BEEN NOTIFIED AND GIVES APPROVAL TO ENERGIZE THE EQUIPMENT

SITE WORK NOTES:

- DO NOT EXCAVATE OR DISTURB BEYOND THE PROPERTY LINES OR LEASE LINES, UNLESS OTHERWISE NOTED.
- SIZE, LOCATION AND TYPE OF ANY UNDERGROUND UTILITIES OR IMPROVEMENTS SHALL 2. BE ACCURATELY NOTED AND PLACED ON AS-BUILT DRAWINGS BY GENERAL CONTRACTOR AND ISSUED TO ARCHITECT/ENGINEER AT COMPLETION OF PROJECT.
- ALL EXISTING UTILITIES, FACILITIES, CONDITIONS AND THEIR DIMENSIONS SHOWN ON 3. PLANS HAVE. BEEN PLOTTED FROM AVAILABLE RECORDS. THE ENGINEER AND OWNER ASSUME NO RESPONSIBILITY WHATSOEVER AS TO THE SUFFICIENCY OR ACCURACY OF THE INFORMATION SHOWN ON THE PLANS OR THE MANNER OF THEIR REMOVAL OR ADJUSTMENT. CONTRACTOR SHALL BE RESPONSIBLE FOR DETERMINING EXACT LOCATION OF ALL EXISTING UTILITIES AND FACILITIES PRIOR TO START OF CONSTRUCTION. CONTRACTOR SHALL ALSO OBTAIN FROM EACH UTILITY COMPANY DETAILED INFORMATION RELATIVE TO WORKING SCHEDULES AND METHODS OF REMOVING OR ADJUSTING EXISTING UTILITIES.
- CONTRACTOR SHALL VERIFY ALL EXISTING UTILITIES BOTH HORIZONTALLY AND VERTICALLY PRIOR TO START OF CONSTRUCTION, ANY DISCREPANCIES OR DOUBTS AS TO THE INTERPRETATION OF PLANS SHALL BE IMMEDIATELY REPORTED TO THE ARCHITECT/ENGINEER OR ZAYO CM FOR RESOLUTION AND INSTRUCTION, AND NO FURTHER WORK SHALL BE PERFORMED UNTIL THE DISCREPANCY IS CHECKED AND CORRECTED BY THE ARCHITECT/ENGINEER. FAILURE TO SECURE SUCH INSTRUCTION MEANS CONTRACTOR WILL HAVE WORKED AT THEIR OWN RISK AND EXPENSE. CONTRACTOR SHALL CALL LOCAL UTILITY LOCATE HOT LINE, SUCH AS 811, FOR UTILITY LOCATIONS A MINIMUM OF 48 HOURS PRIOR TO START OF CONSTRUCTION
- ALL NEW AND EXISTING UTILITY STRUCTURES ON SITE AND IN AREAS TO BE DISTURBED BY CONSTRUCTION SHALL BE ADJUSTED TO FINISH ELEVATIONS PRIOR TO FINAL INSPECTION OF WORK. ANY COST RELATED TO ADJUSTING EXISTING STRUCTURES SHALL BE BORNE SOLELY BY THE CONTRACTOR.
- GRADING OF THE SITE WORK AREA IS TO BE SMOOTH AND CONTINUOUS IN SLOPE AND IS TO FEATHER INTO EXISTING GRADES AT THE GRADING LIMITS.
- ALL TEMPORARY EXCAVATIONS FOR THE INSTALLATION OF FOUNDATIONS, UTILITIES, ETC., 7 SHALL BE PROPERLY LAID BACK OR BRACED IN ACCORDANCE WITH CORRECT OCCUPATIONAL SAFETY AND HEALTH ADMINISTRATION (OSHA) REQUIREMENTS.
- STRUCTURAL FILLS SUPPORTING PAVEMENTS SHALL BE COMPACTED TO 95% OF MAXIMUM STANDARD PROCTOR DRY DENSITY, UNLESS OTHERWISE NOTED.
- NEW GRADES NOT IN BUILDING AND DRIVEWAY IMPROVEMENT AREA TO BE ACHIEVED BY FILLING WITH APPROVED CLEAN FILL AND COMPACTED TO 95% OF STANDARD PROCTOR DENSITY

- EQUIPMENT AVAILABLE
- GEOTECHNICAL ENGINEER
- BY THE GENERAL CONTRACTOR
- SHALL BE PROTECTED BY THE GENERAL CONTRACTOR.
- HAVING JURISDICTION OVER THIS LOCATION.

ENVIRONMENTAL NOTES:

- FOR AREAS IN VIOLATION
- 2. JURISDICTIONAL INSPECTION & RELEASE OF SITE.
- 3. THE LIMITS OF SITE DISTURBANCE PRIOR TO CONSTRUCTION.
- FROSION
- 5.
- 6.
- 7 SHALL BE REMOVED.
- 8. DISTURBANCE
- BARRIERS, AND CHECK DAMS
- 10. OIL. ALKALI, OR OTHER DELETERIOUS SUBSTANCES.

ONSULTANT

10. ALL FILL SHALL BE PLACED IN UNIFORM LIFTS, THE LIFTS THICKNESS SHOULD NOT EXCEED THAT WHICH CAN BE PROPERLY COMPACTED THROUGHOUT ITS ENTIRE DEPTH WITH THE

11. ANY FILLS PLACED ON EXISTING SLOPES THAT ARE STEEPER THAN 10 HORIZONTAL TO 1 VERTICAL SHALL BE PROPERLY BENCHED INTO THE EXISTING SLOPE AS DIRECTED BY A

12. CONTRACTOR SHALL CLEAN ENTIRE SITE AFTER CONSTRUCTION SUCH THAT NO DEBRIS, PAPER, TRASH, WEEDS, BRUSH, EXCESS FILL, OR ANY OTHER DEPOSITS WILL REMAIN. ALL MATERIALS COLLECTED DURING CLEANING OPERATIONS SHALL BE DISPOSED OF OFF-SITE

13. ALL TREES AND SHRUBS WHICH ARE NOT IN DIRECT CONFLICT WITH THE IMPROVEMENTS

14. ALL SITE WORK SHALL BE CAREFULLY COORDINATED BY GENERAL CONTRACTOR WITH LOCAL UTILITY COMPANY, TELEPHONE COMPANY, AND ANY OTHER UTILITY COMPANIES

ALL WORK PERFORMED SHALL BE DONE IN ACCORDANCE WITH ISSUED PERMITS. THE CONTRACTOR SHALL BE RESPONSIBLE FOR PAYMENT OF FINES AND PROPER CLEAN UP

CONTRACTOR SHALL BE RESPONSIBLE FOR CONSTRUCTION AND MAINTENANCE OF EROSION AND SEDIMENTATION CONTROLS DURING CONSTRUCTION FOR PROTECTION OF ADJACENT PROPERTIES, ROADWAYS AND WATERWAYS. ALL EROSION AND SEDIMENTATION CONTROLS SHALL BE MAINTAINED IN PLACE THROUGH FINAL

CONTRACTOR SHALL INSTALL/CONSTRUCT ALL NECESSARY SEDIMENT/SILT CONTROL FENCING AND PROTECTIVE MEASURES AS REQUIRED BY THE LOCAL JURISDICTION WITHIN

NO SEDIMENT SHALL BE ALLOWED TO EXIT THE PROPERTY. THE CONTRACTOR IS RESPONSIBLE FOR TAKING ADEQUATE MEASURES FOR CONTROLLING EROSION. ADDITIONAL SEDIMENT CONTROL FENCING MAY BE REQUIRED IN ANY AREAS SUBJECT TO

THE CONTRACTOR IS RESPONSIBLE FOR MAINTAINING POSITIVE DRAINAGE ON THE SITE AT ALL TIMES WITH SILT AND EROSION CONTROL MEASURES MAINTAINED ON THE DOWNSTREAM SIDE OF SITE DRAINAGE. ANY DAMAGE TO ADJACENT PROPERTY AS A RESULT OF EROSION WILL BE CORRECTED AT THE CONTRACTORS EXPENSE.

CONTRACTOR SHALL BE RESPONSIBLE FOR DAILY INSPECTIONS AND ANY REPAIRS OF ALL SEDIMENT CONTROL MEASURES INCLUDING SEDIMENT REMOVAL AS NECESSARY.

CLEARING OF VEGETATION AND TREE REMOVAL SHALL BE ONLY AS PERMITTED AND BE HELD TO A MINIMUM. ONLY TREES NECESSARY FOR CONSTRUCTION OF THE FACILITIES

SEEDING AND MULCHING AND/OR SODDING OF THE SITE WILL BE ACCOMPLISHED AS SOON AS POSSIBLE AFTER COMPLETION OF THE PROJECT FACILITIES AFFECTING LAND

CONTRACTOR SHALL PROVIDE ALL EROSION AND SEDIMENTATION CONTROL MEASURES AS REQUIRED BY LOCAL, COUNTY AND STATE CODES AND ORDINANCES TO PROTECT EMBANKMENTS FROM SOIL LOSS AND TO PREVENT ACCUMULATION OF SOIL AND SILT IN STREAMS AND DRAINAGE PATHS LEAVING THE CONSTRUCTION AREA. THIS MAY INCLUDE, BUT IS NOT LIMITED TO SUCH MEASURES AS SILT FENCES, STRAW BALE SEDIMENT

RIP RAP OF SIZES INDICATED SHALL CONSIST OF CLEAN, HARD, SOUND, DURABLE, UNIFORM IN QUALITY STONE FREE OF ANY DETRIMENTAL QUANTITY OF SOFT, FRIABLE THIN, ELONGATED OR LAMINATED PIECES, DISINTEGRATED MATERIAL, ORGANIC MATTER,

11. GC TO PLACE FILTER MATERIAL AT ALL CATCH BASINS ADJACENT TO CONSTRUCTION SITE TO PREVENT SOLID WASTE CONTAMINATION FROM ENTERING SEWER SYSTEM.

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		GENERAL SPECIFICATIONS	SITE NAME: PORTILLO'S CASCADE ID: MS90XSU24-N MAPLE GROVE, MINNESOTA				
SHEET TITLE:							
SUBM INT. NAT	DA DA	TE:	DESCRIPTION: REV. A				
NAT	05/2-	4/18	REV. 0				
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PLOT DATE			(17/2018				
PRO. NUM	JECT	17:	258				
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FOUNDATION, EXCAVATION AND BACKFILL NOTES:

- ALL FINAL GRADED SLOPES SHALL BE A MAXIMUM OF 3 HORIZONTAL TO 1 VERTICAL, UNLESS OTHERWISE NOTED.
- BACKFILL OF POLE SHALL BE PERFORMED IN ONE OF TWO OPTIONS: 2.

A. PREFERRED: RAINBOW INDUSTRIES POLE SETTING FOAM SHALL BE INSTALLED PER MANUFACTURER SPECS. FOAM SHALL ALWAYS BE USED FOR POOR SOILS.

B. SECONDARY: CONCRETE (REQUIRES ZAYO CM WRITTEN APPROVAL) ALLOWABLE SOIL PRESSURE = 2500 PSF (ASSUMED). NON-NATIVE SOILS SHALL BE REMOVE FROM BORE AREA AND SHALL NOT BE REUSED FOR BACKFILL

- ALL EXCAVATIONS PREPARED FOR PLACEMENT OF CONCRETE SHALL BE OF 3. UNDISTURBED SOILS, SUBSTANTIALLY HORIZONTAL AND FREE FROM ANY LOOSE, UNSUITABLE MATERIAL OR FROZEN SOILS, AND WITHOUT THE PRESENCE OF POUNDING WATER. DEWATERING FOR EXCESS GROUND WATER SHALL BE PROVIDED WHEN REQUIRED, COMPACTION OF SOILS LINDER CONCRETE PAD FOUNDATIONS SHALL NOT BE LESS THAN 95% OF THE MODIFIED PROCTOR MAXIMUM DRY DENSITY FOR THE SOIL IN ACCORDANCE WITH ASTM D1557.
- CONCRETE FOUNDATIONS SHALL NOT BE PLACED ON ORGANIC OR UNSUITABLE 4. MATERIAL. IF ADEQUATE BEARING CAPACITY IS NOT ACHIEVED AT THE DESIGNED EXCAVATION DEPTH, THE UNSATISFACTORY SOIL SHALL BE EXCAVATED TO ITS FULL DEPTH AND EITHER BE REPLACED WITH MECHANICALLY COMPACTED GRANULAR MATERIAL OR THE EXCAVATION SHALL BE FILLED WITH CONCRETE OF THE SAME TYPE SPECIFIED FOR THE FOUNDATION. CRUSHED LIME STONE #57 MAY BE USED TO STABILIZE THE BOTTOM OF THE EXCAVATION. ANY STONE SUB BASE MATERIAL, IF USED, SHALL NOT SUBSTITUTE FOR REQUIRED THICKNESS OF CONCRETE.
- ALL EXCAVATIONS SHALL BE CLEAN OF UNSUITABLE MATERIAL SUCH AS VEGETATION, 5. TRASH, DEBRIS, AND SO FORTH PRIOR TO BACK FILLING. BACK FILL SHALL CONSIST OF APPROVED MATERIALS SUCH AS EARTH, LOAM, SANDY CLAY, SAND AND GRAVEL, OR SOFT SHALE, FREE FROM CLODS OR LARGE STONES OVER 2 1/2" MAX DIMENSIONS. ALL BACK FILL SHALL BE PLACED IN COMPACTED LAYERS
- ALL FILL MATERIALS AND FOUNDATION BACK FILL SHALL BE PLACED IN MAXIMUM 6" THICK LIFTS BEFORE COMPACTION. EACH LIFT SHALL BE WETTED IF REQUIRED AND COMPACTED TO NOT LESS THAN 95% OF THE MODIFIED PROCTOR MAXIMUM DRY DENSITY FOR SOIL IN ACCORDANCE WITH ASTM D1557
- NEWLY PLACED CONCRETE FOUNDATIONS SHALL CURE A MINIMUM OF 72 HRS PRIOR TO 7. BACK FILLING.
- FINISHED GRADING SHALL BE SLOPED TO PROVIDE POSITIVE DRAINAGE AND PREVENT STANDING WATER. THE FINAL (FINISH) ELEVATION OF SLAB FOUNDATIONS SHALL SLOPE AWAY IN ALL DIRECTIONS FROM THE CENTER. FINISH GRADE OF CONCRETE PADS SHALL BE A MAXIMUM OF 4 INCHES ABOVE FINAL FINISH GRADE FLEVATIONS PROVIDE SURFACE FILL GRAVEL TO ESTABLISH SPECIFIED ELEVATIONS WHERE REQUIRED.
- NEWLY GRADED GRAVEL SURFACE AREAS TO RECEIVE GRAVEL SHALL BE COVERED WITH GEOTEXTILE FABRIC TYPE: TYPAR-3401 AS MANUFACTURED BY TYPAR GEOSYNTHETICS OR AN APPROVED EQUIVALENT, SHOWN ON PLANS, THE GEOTEXTILE FABRIC SHALL BE BLACK IN COLOR TO CONTROL THE RECURRENCE OF VEGETATIVE GROWTH AND EXTEND TO WITHIN 1 FOOT OUTSIDE THE SITE FENCING OR ELECTRICAL GROUNDING SYSTEM PERIMETER WHICH EVER IS GREATER. ALL FABRIC SHALL BE COVERED WITH A MINIMUM OF 4" DEEP COMPACTED STONE OR GRAVEL AS SPECIFIED. I.E. FDOT TYPE NO. 57 FOR FENCED COMPOUND; FDOT TYPE NO. 67 FOR ACCESS DRIVE AREA, UNLESS OTHERWISE NOTED
- 10. IN ALL AREAS TO RECEIVE FILL: REMOVE ALL VEGETATION, TOPSOIL, DEBRIS, WET AND UNSATISFACTORY SOIL MATERIALS OBSTRUCTIONS AND DELETERIOUS MATERIALS FROM GROUND SURFACE, PLOW STRIP OR BREAK UP SLOPED SURFACES STEEPER THAN 1 VERTICAL TO 4 HORIZONTAL SUCH THAT FILL MATERIAL WILL BIND WITH (E)/PREPARED SOIL SURFACE.
- WHEN SUB GRADE OR PREPARED GROUND SURFACE HAS A DENSITY LESS THAN THAT 11. REQUIRED FOR THE FILL MATERIAL. SCARIFY THE GROUND SURFACE TO DEPTH REQUIRED. PULVERIZE, MOISTURE-CONDITION AND/OR AERATE THE SOILS AND RECOMPACT TO THE REQUIRED DENSITY PRIOR TO PLACEMENT OF FILLS
- IN AREAS WHICH EXISTING GRAVEL SURFACING IS REMOVED OR DISTURBED DURING 12. CONSTRUCTION OPERATIONS, REPLACE GRAVEL SURFACING TO MATCH ADJACENT GRAVEL SURFACING AND RESTORED TO THE SAME THICKNESS AND COMPACTION AS SPECIFIED. ALL RESTORED GRAVEL SURFACING SHALL BE FREE FROM CORRUGATIONS AND WAVES
- EXISTING GRAVEL SURFACING MAY NOT BE REUSED. 13.
- GRAVEL SUB SURFACE SHALL BE PREPARED TO REQUIRED COMPACTION AND SUB GRADE 14. ELEVATIONS BEFORE GRAVEL SURFACING IS PLACED AND/OR RESTORED. ANY LOOSE OR DISTURBED MATERIALS SHALL BE THOROUGHLY COMPACTED AND ANY DEPRESSIONS IN THE SUB GRADE SHALL BE FILLED AND COMPACTED WITH APPROVED SELECTED MATERIAL. GRAVEL SURFACING MATERIAL SHALL NOT BE USED FOR FILLING DEPRESSIONS IN THE SUB GRADE.

- 15. PROTECT EXISTING GRAVEL SURFACING AND SUB GRADE IN AREAS WHERE EQUIPMENT LOADS WILL OPERATE. USE PLANKING 'MATTS' OR OTHER SUITABLE PROTECTION DESIGNED TO SPREAD EQUIPMENT LOADS AS MAY BE NECESSARY. REPAIR ANY DAMAGE TO EXISTING GRAVEL SURFACING OR SUB GRADE WHERE SUCH DAMAGE IS DUE TO THE CONTRACTORS OPERATIONS.
- 16 DAMAGE TO EXISTING STRUCTURES AND/OR UTILITIES RESULTING FROM CONTRACTORS NEGLIGENCE SHALL BE REPAIRED AND/ OR REPLACED TO THE OWNERS SATISFACTION AT NO ADDITIONAL COST TO THE CONTRACT.
- 17. ALL SUITABLE BORROW MATERIAL FOR BACK FILL OF THE SITE SHALL BE INCLUDED IN THE BID. EXCESS TOPSOIL AND UNSUITABLE MATERIAL SHALL BE DISPOSED OF OFF SITE AT LOCATIONS APPROVED BY GOVERNING AGENCIES AT NO ADDITIONAL COST TO THE CONTRACT

CONCRETE AND STEEL REINFORCEMENT

- CELLULAR PRIOR TO USE.
- 2. VENDOR
- 3.
- 4. THE REQUIREMENTS OF ASTM C33
- 5 STRENGTH = 60 000 PSI
- 6.
- WELDED WIRE FABRIC SHALL CONFORM TO ASTM A185 8.
- 10. OTHERWISE.
- PLACING REINFORCING STEEL
- PROVISION DO NOT PLACE CONCRETE ON FROZEN SUBGRADE
- REINFORCING STEEL.
- 15.
- 16. PROVIDE AN BONDING AGENT TO CONSTRUCTION JOINT.
- 18 TO MAINTAIN MOISTURE AND TEMPERATURE OF CONCRETE

- 21. PROVIDE TEST CYLINDERS AS FOLLOWS:

A. EQUIPMENT ENCLOSURE: 1 CYLINDER AT 7 DAYS. 1 CYLINDER AT 14 DAYS. 2 CYLINDERS AT 28 DAYS.

CONCRETE SHALL BE MIXED AND DELIVERED IN ACCORDANCE WITH ASTM C94. CONCRETE SHALL BE 6 BAG MIX HAVING A 28 DAY COMPRESSIVE STRENGTH OF 4000 PSI. MAXIMUM AGGREGATE SIZE OF 1", MAXIMUM WATER CEMENT RATIO OF 0.45, AIR ENTRAINMENT OF 6% +/- 1%, AND SLUMP OF 3" +/- 1". DEVIATIONS FROM THE MIX MUST BE APPROVED BY U.S.

CONCRETE CONSTRUCTION SHALL BE COMPLETED IN ACCORDANCE WITH THE MOST STRINGENT OF: PROJECT PLANS, SPECIAL PROVISIONS, OR THE AMERICAN CONCRETE INSTITUTE (ACI) PUBLICATIONS CONCRETE WORK FOR TOWER FOUNDATIONS SHALL BE COMPLETED IN ACCORDANCE WITH PLANS AND SPECIFICATIONS PROVIDED BY THE TOWER

FORM MATERIALS WILL COMPLY WITH ACI 301. PLYWOOD FORMS SHALL BE APA B-B PLYFORM CLASS I SOUND SHEETS. LUMBER SHALL BE SPRUCE-PINE-FIR SPECIES #2 OR BETTER GRADE. TUBULAR COLUMN FORMS MAY BE SPIRALLY WOUND LAMINATED FIBER MATERIAL. FORM TIES SHALL BE REMOVABLE OR SNAP-OFF METAL TYPE.

CONCRETE SHALL BE MADE OF CEMENT MEETING THE REQUIREMENTS OF ASTM C150, NORMAL, TYPE I PORTLAND. FINE AND COARSE AGGREGATES FOR CONCRETE SHALL MEET

PLACE, SUPPORT AND SECURE REINFORCEMENT STEEL AT LOCATIONS SHOWN ON PLANS. REINFORCING STEEL SHALL BE PLACED IN ACCORDANCE WITH ACI 315. REBAR YIELD

AIR ENTRAINING ADMIXTURES SHALL MEET THE REQUIREMENTS OF ASTM C260; WATER REDUCING ADMIXTURES SHALL MEET THE REQUIREMENTS OF ASTM C494, TYPE A. ALL OTHER ADMIXTURES ARE PROHIBITED WITHOUT PRIOR APPROVAL BY U.S. CELLULAR.

CURING COMPOUND SHALL MEET THE REQUIREMENTS OF ASTM C309.

9. ALL CONSTRUCTION AND EXPANSION JOINTS SHALL BE INSTALLED PER THE DRAWINGS.

ALL EXPOSED CORNERS OF CONCRETE WORK SHALL BE CHAMFERED 3/4 " UNLESS NOTED

11. PLACE, SUPPORT AND SECURE REINFORCEMENT STEEL PER STRUCTURAL ANALYSIS. REINFORCING STEEL SHALL BE PLACED IN ACCORDANCE WITH ACI 315.

12. ALL FORM WORK SHALL BE RIGID, TIGHT, LEVEL, PLUMB AND SUFFICIENTLY SHORED TO RESIST CONSTRUCTION LOAD CONDITIONS. COAT FORMS WITH RELEASE AGENT PRIOR TO

13. PREPARE SUBGRADE FOR CONCRETE IN ACCORDANCE WITH PROJECT PLANS AND SPECIAL

14. UTILIZE CHUTES, TROUGHS OR CONVEYORS TO PLACE CONCRETE SO THAT HANDLING OF CONCRETE IS MINIMIZED. AVOID SEGREGATION OF THE AGGREGATE AND DISTURBING

UNIFORMLY CONSOLIDATE CONCRETE USING HAND TOOLS OR MECHANICAL VIBRATORS. THOROUGHLY CONSOLIDATE EACH LAYER PRIOR TO PLACING SUBSEQUENT LAYERS.

WHEN PLACING OPERATIONS ARE TEMPORARILY SUSPENDED, THE UNFINISHED FACE OF THE POUR SHALL BE COVERED WITH WET BURLAP UNTIL PLACING OPERATIONS ARE RESUMED. WHEN PLACING OPERATIONS ARE SUSPENDED FOR MORE THAN 30 MINUTES,


17. TROWEL FINISH SURFACES UNLESS OTHERWISE DIRECTED ON THE PLANS.

AFTER FINAL FINISHING, PROVIDE POLYETHYLENE VAPOR BARRIER OR CURING COMPOUND


19. IN EXTREME WEATHER PLACE AND CURE CONCRETE IN ACCORDANCE WITH EITHER ACI 306R-89 FOR COLD WEATHER OR ACI 305R-89 FOR HOT WEATHER.

20. REMOVE FORMS IN A MANNER THAT DOES NOT DAMAGE THE CONCRETE. FILL AND PATCH POCKETS OR HOLES ON EXPOSED SURFACES USING MORTAR MIXTURE


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	GENERAL SPECIFICATIONS	SITE NAME: PORTILLO'S CASCADE ID: MS90XSU24-N MAPLE GROVE, MINNESOTA
SHEET TITLE:		
SUBMITTAL INT. DA NAT 04/1	TE:	DESCRIPTION: REV. A
NAT 05/2		REV. 0
NAT 10/1	7/18	REV. 1
CHECKED BY PLOT	MF	
PLOT DATE PROJECT		17/2018
NUMBER		258
SET TYPE	G-004	

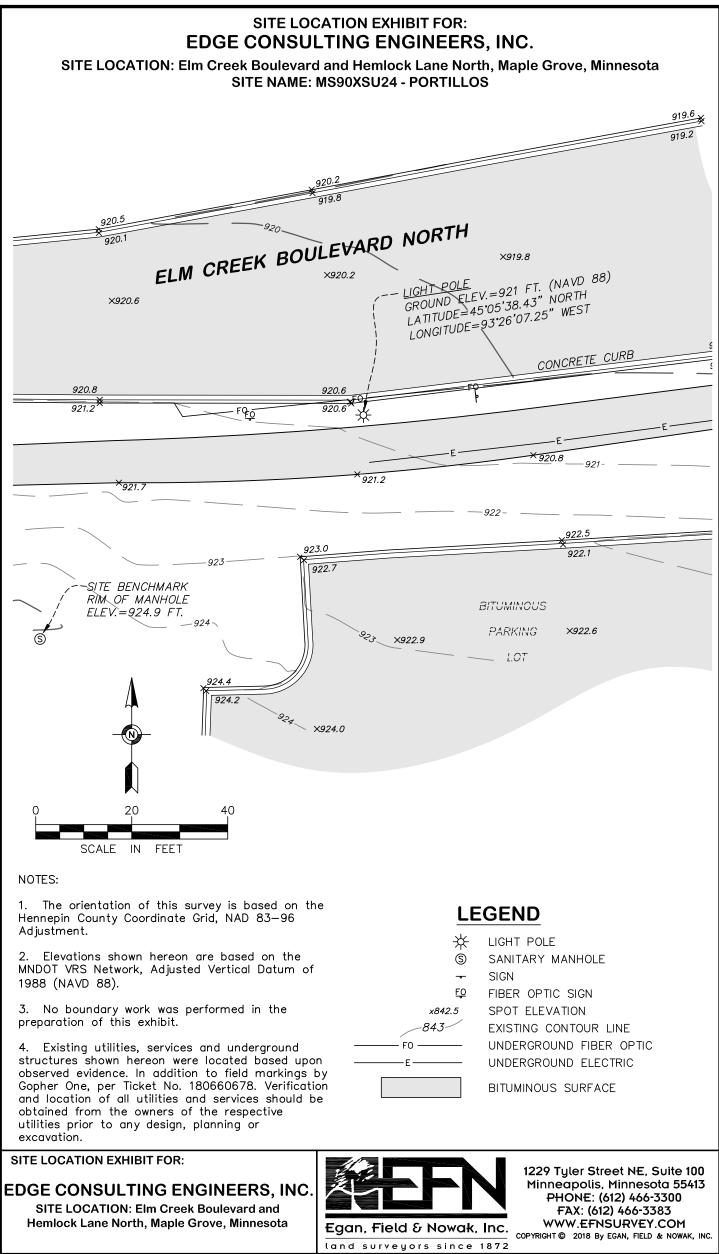

DRAWING NAME: 37727 PORTILLOS.dwg

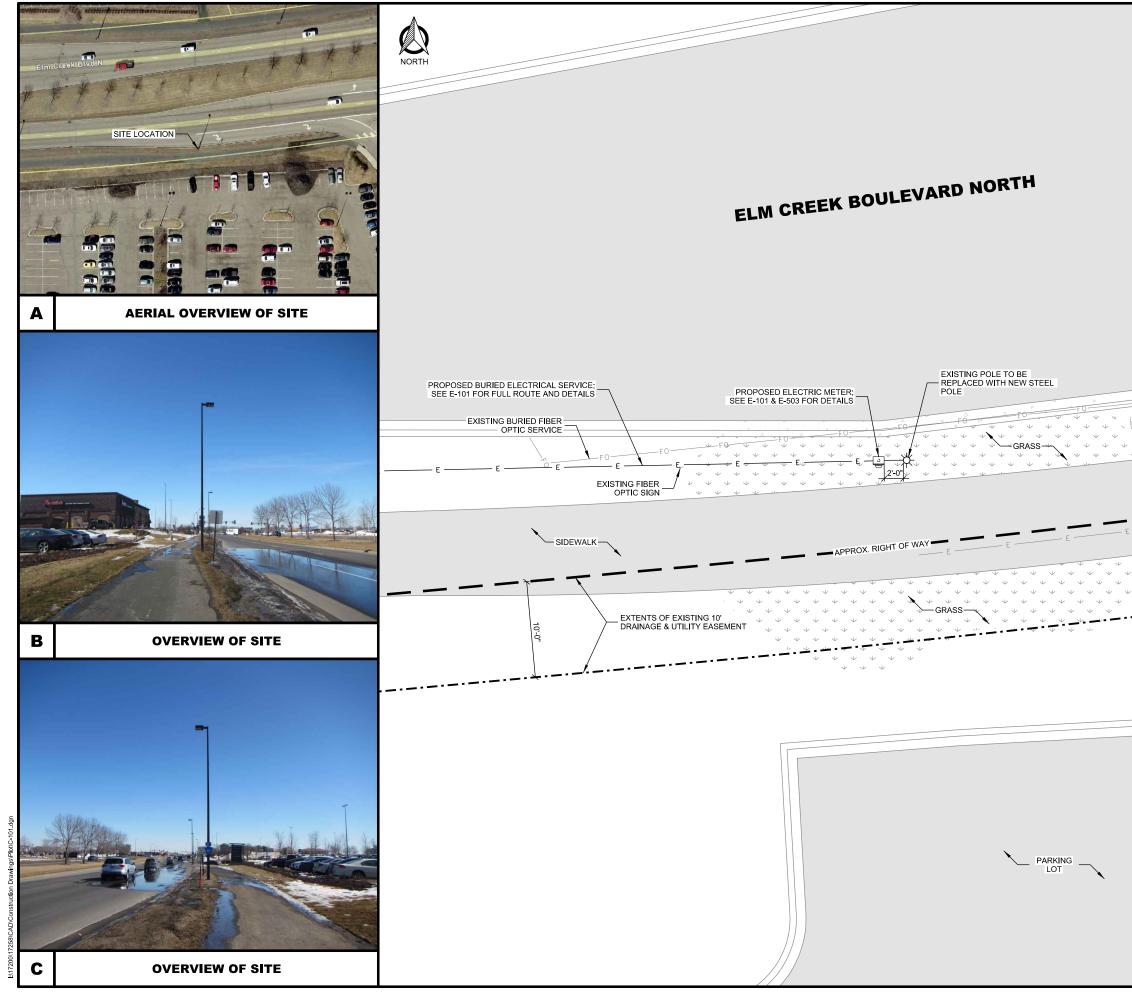

	CONSULTANT:
EXISTING STREET SIGN	SITE PLAN SITE NAME: PORTILLO'S CASCADE ID: MS90XSU24-N MAPLE GROVE, MINNESOTA
	Ц SUBMITTAL: INT. DATE: DESCRIPTION: NAT 04/19/18 REV. A NAT 05/24/18 REV. 0 NAT 10/17/18 REV. 1 10/17/18 REV. 1 10/17/18 REV. 1
5' 0 5' 10' SCALE: 11" x 17" - 1" = 10' 22" x 34" - 1" = 5'	CHECKED BY DATE 10/17/2018 PROJECT 17258 SET TYPE FINAL CDS SHEET NUMBER C-101

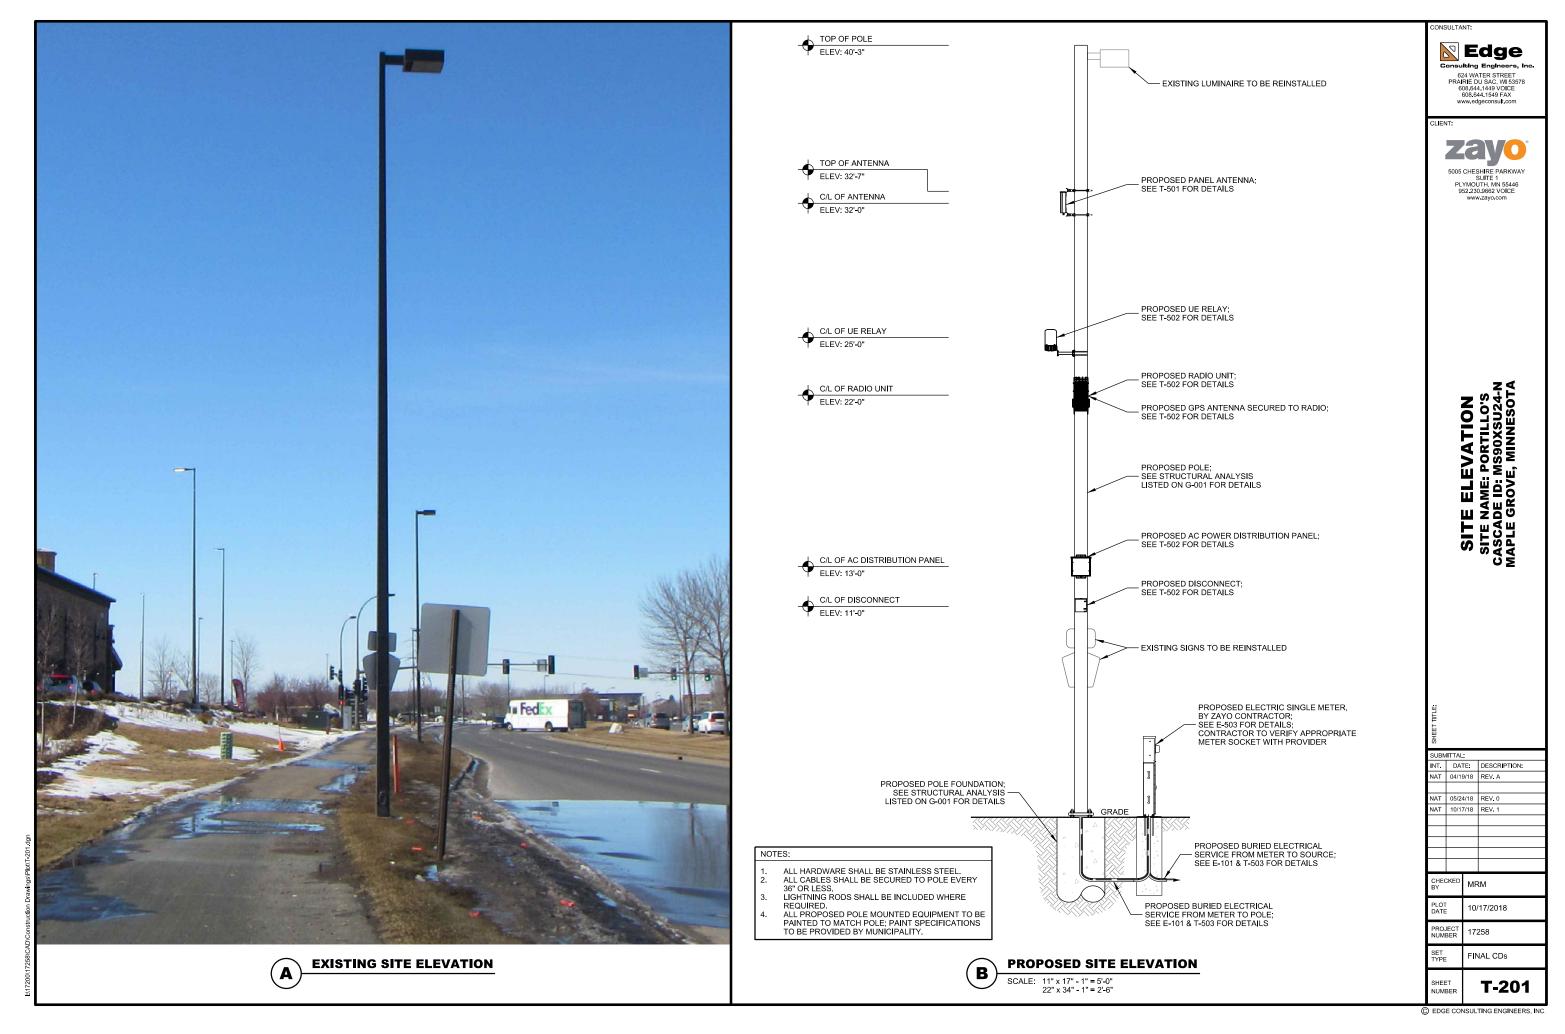

AW3406-S Data Sheet



2496-2690MHz Pico Sector Antenna

(Quad Port, 65° Beamwidth, +/-45° Polarisation, FT)

*The parameters in this specification follow the definitions and recommendations per NGMN P-Basta, Release 9.6


RF Specifications

Frequency Range per Input	MHz	2496 - 2690
Polarisation:	NA	+/-45° Slant Linear
Gain		
Over all Tilts	dBi	13.5
Azimuth Beamwidth	Degree	65
Azimuth Beam Squint	Degree <	3
Elevation Beamwidth	Degree	22
Electrical Downtilt:	Degree	T0°
Electrical Downtilt Deviation	Degree <	1
Impedance	Ohms	50
VSWR	NA <	1.4
Return Loss:	dB >	15
Isolation	dB >	28
Passive Intermodulation	dBc <	-150
Front to Back Ratio: Total Power +/-30°	dB >	28
Upper Sidelobe Suppression, Peak to 20º	dB >	18
Cross Polar Discrimination at Sector	dB >	16
Maximum Effective Power Per Port	W	50





Mechanical Specifications

Dimensions (LxWxD) mm (in)	mm (in)	368 (14.5) x 280 (11) x 85 (3)
Packing Size (LxWxD)	mm (in)	460 (18) x 320 (12.6) x 178 (3.7)
Net Weight (antenna)	kg (lb)	3 (6.6)
Net Weight (mount)	kg (lb)	0.5 (1.1)
Shipping Weight	kg (lb)	3.5 (7.7)
Connector Quantity	NA	4 x Mini Din
Connector Position	NA	Bottom
Windload calculation	km/h	F=1/2*ρ*(Cdp*λ)*v2*A
Windload Frontal	N	180
Windload Lateral	N	67
Survival Wind Speed	km/h	200
Radome Material	NA	UV-Stabilised PVC
Radome Colour	RAL	7035
Product Compliance Environmental	NA	RoHS
Lightening Protection	NA	DC Grounded
Cold Temperature Survival	Celsius	-40
Hot Temperature Survival	Celsius	+ 70

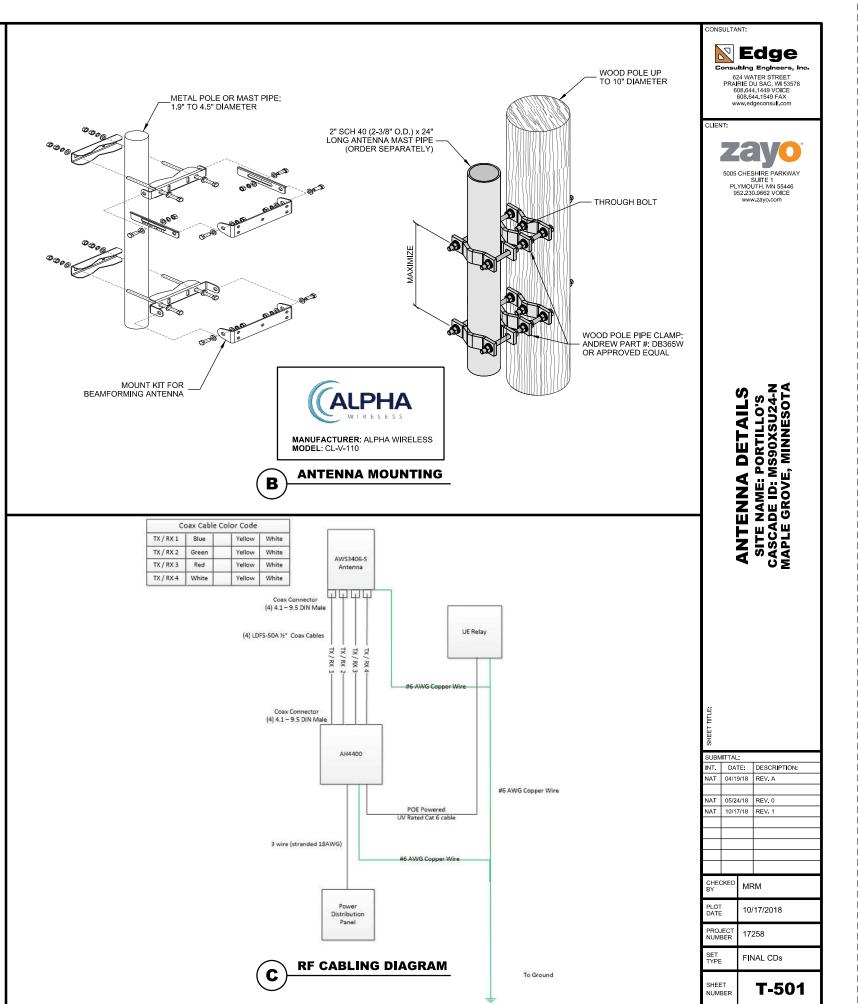

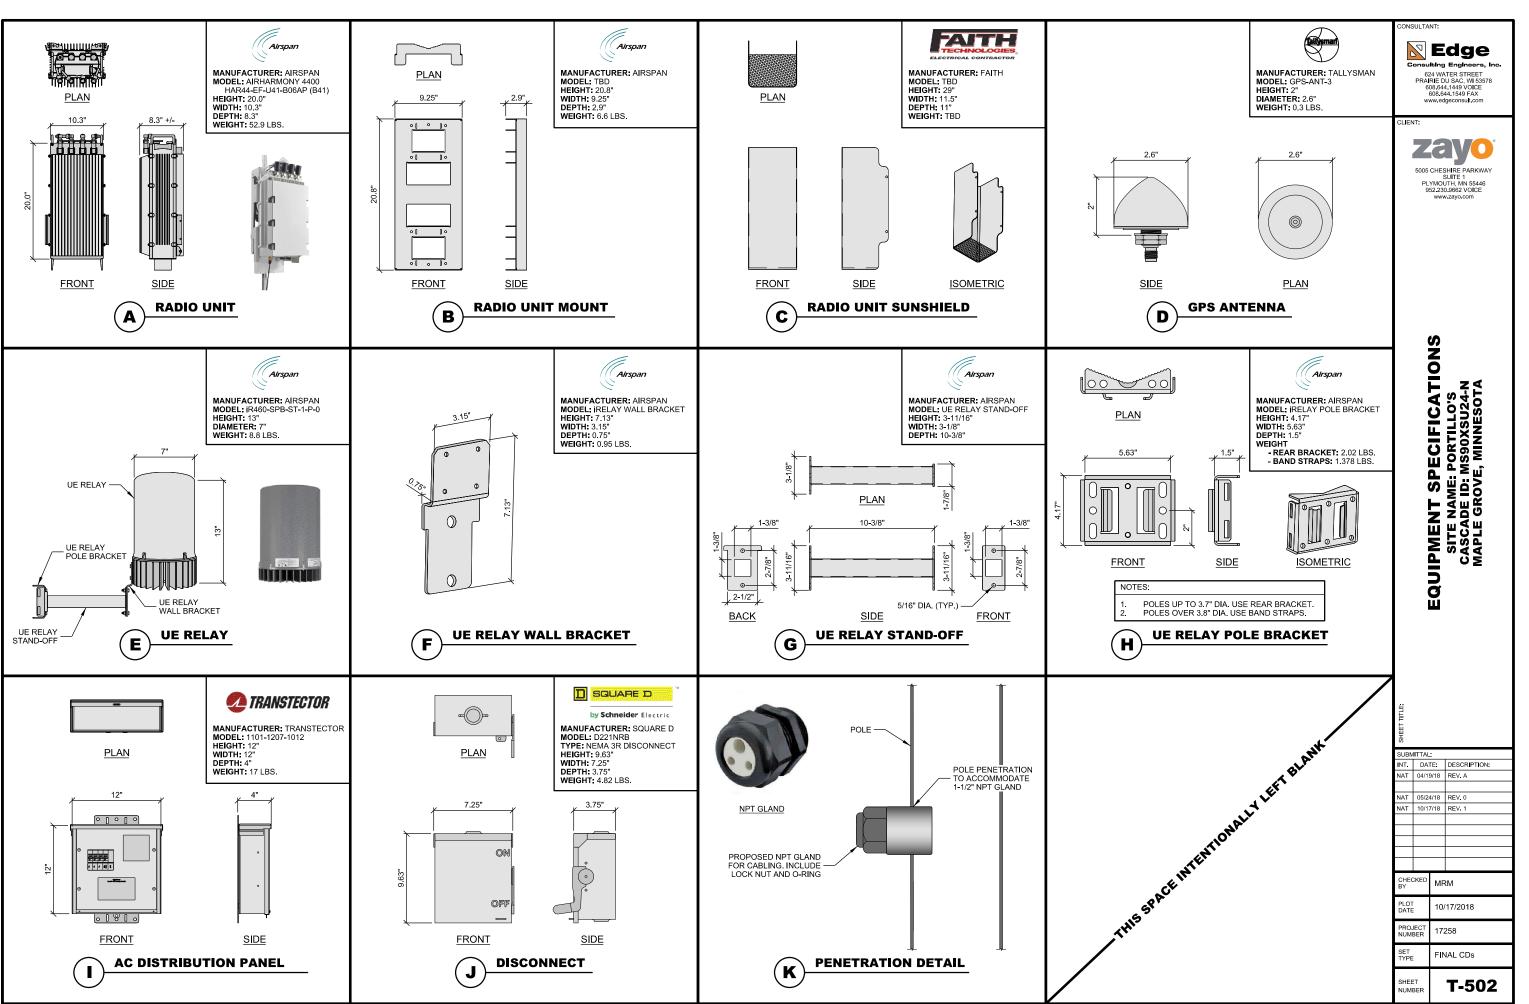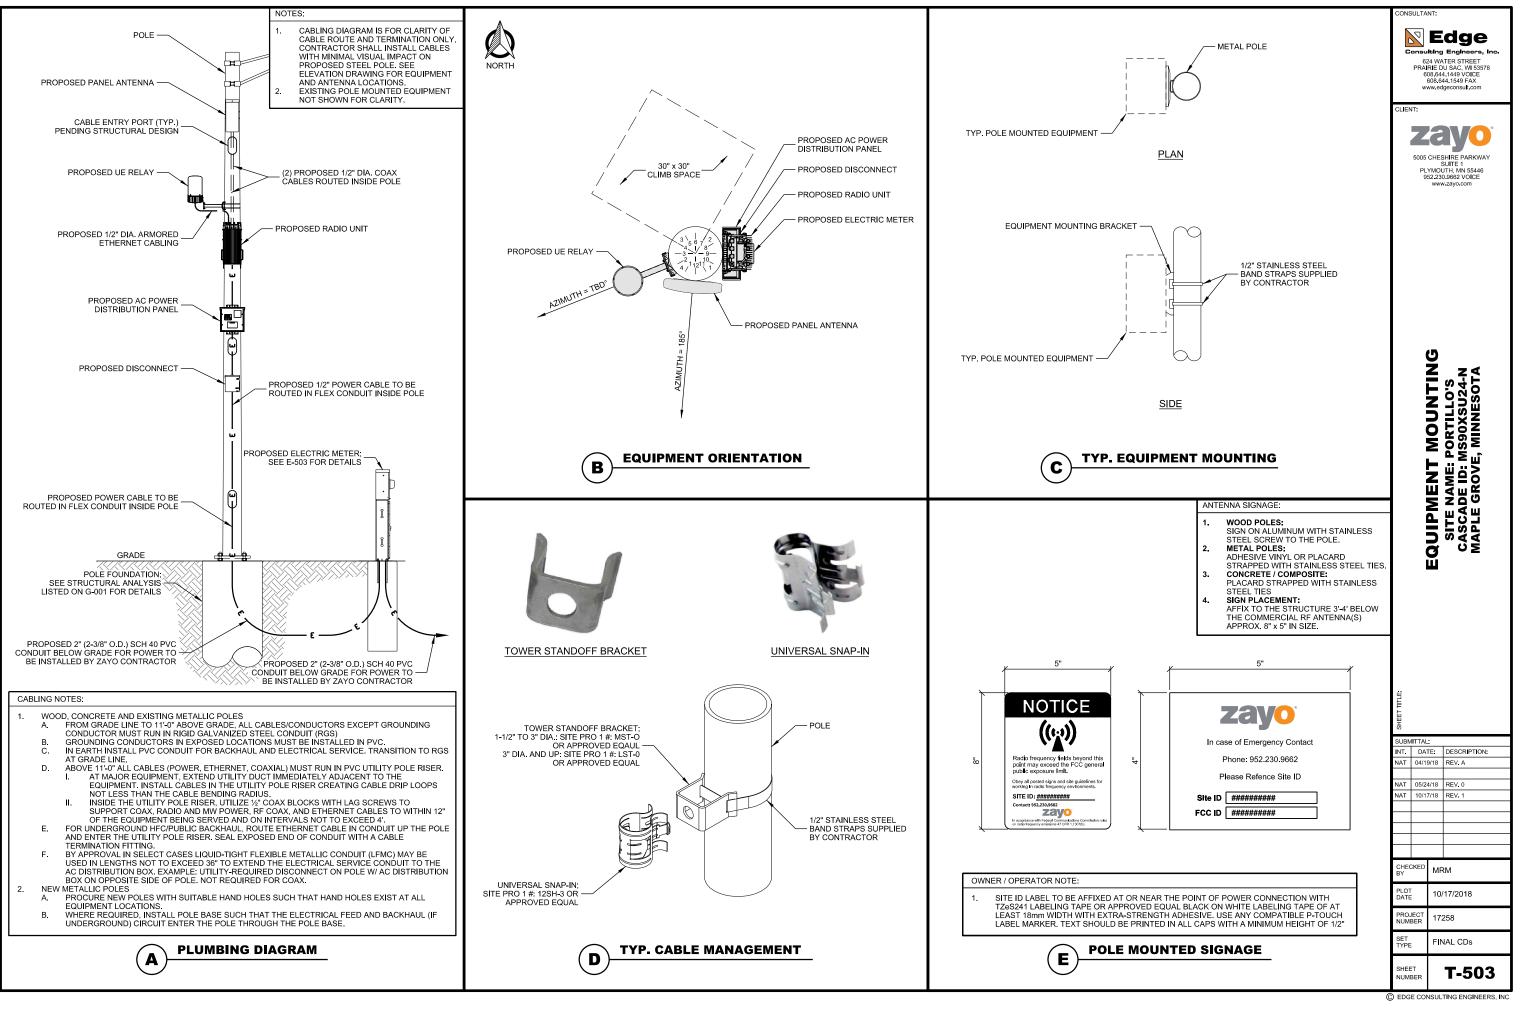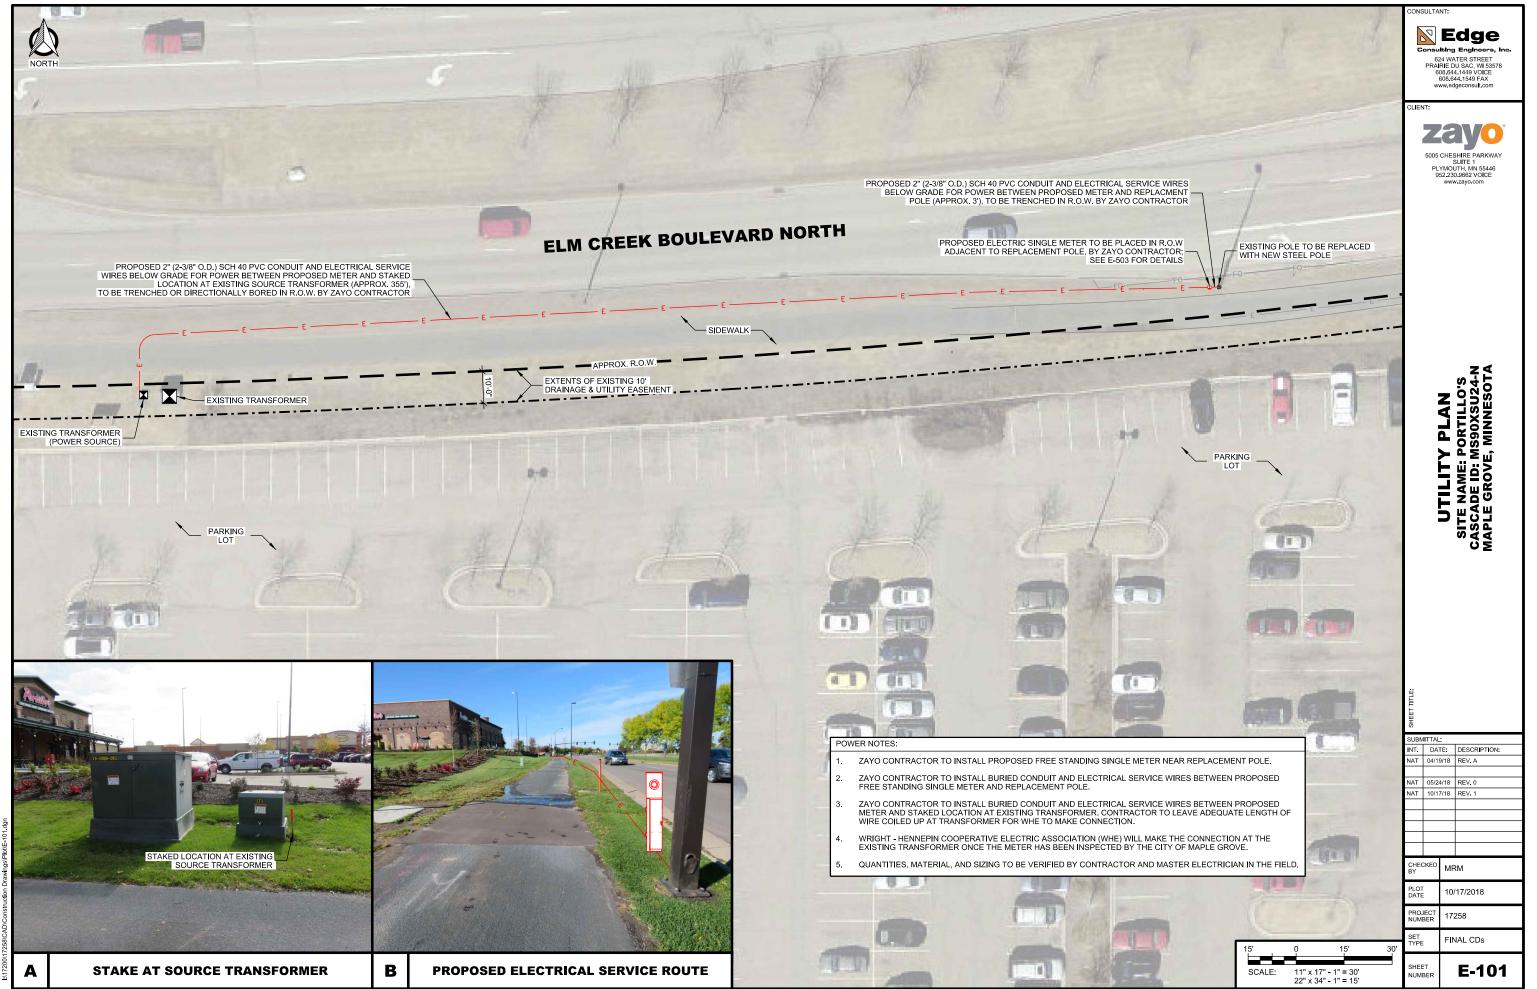
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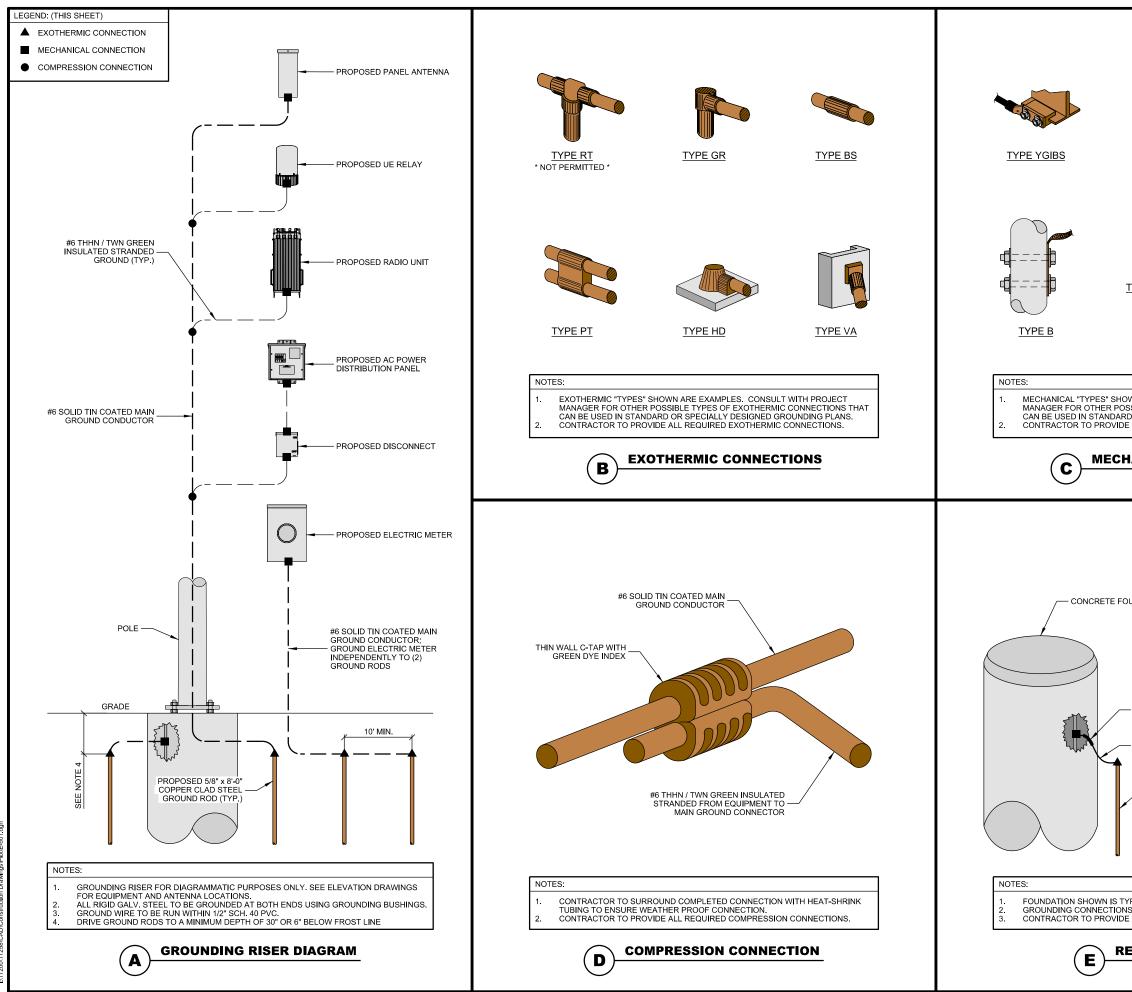





8\CAD\Construction Drawing






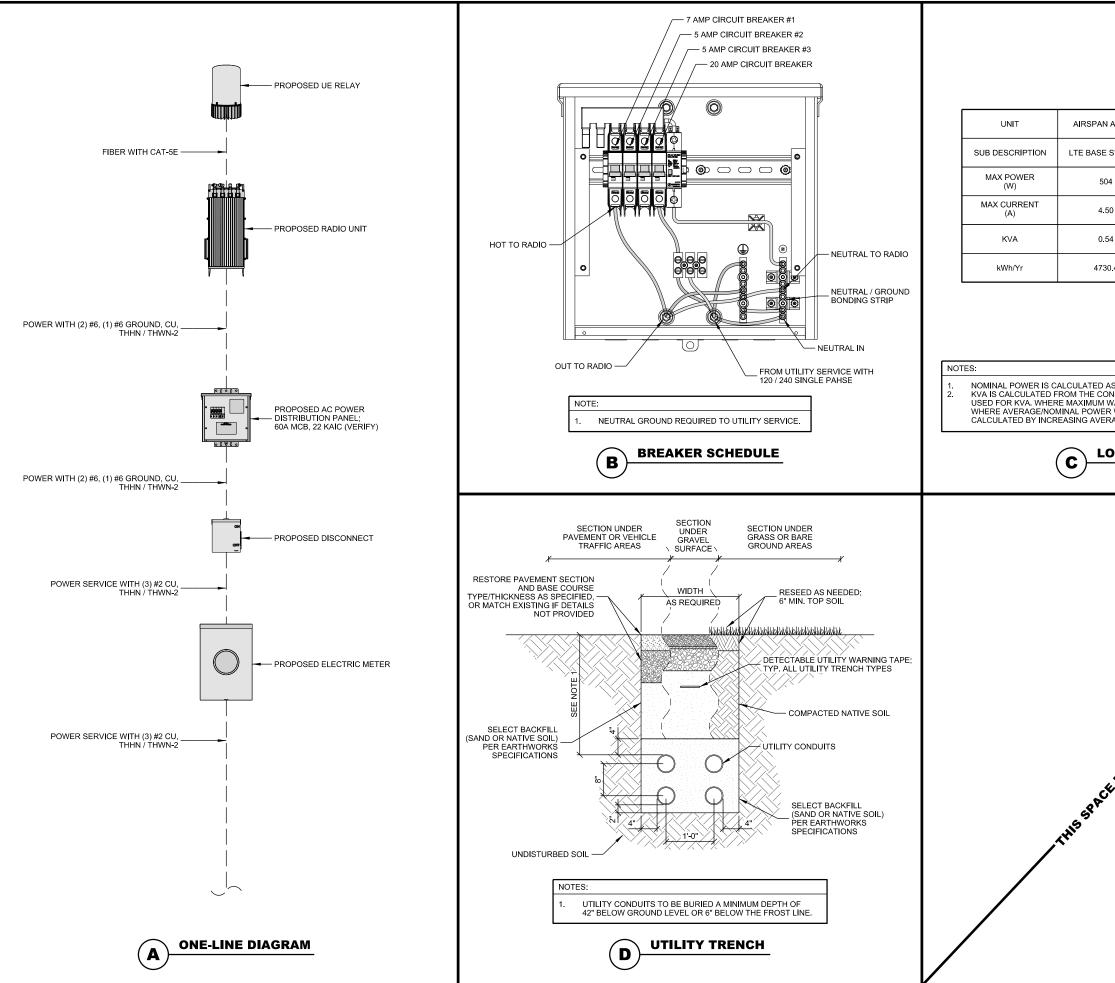
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WRAP GROUND LEAD IN HEAT SHRINK "A" - PARALLEL MOUNT "B" - PERP. MOUNT (SHOWN) WRAP GROUND LEAD IN HEAT SHRINK TAPE AT CONCRETE/GROUND INTERFACE TO PREVENT CORROSION PROPOSED #2 SOLID TINNED COPPER LEAD CONNECTED TO REBAR W/ MECHANICAL CLAMP; HARGER PART #RB12A/B (OR EQUIVALENT) PROPOSED GROUND ROD TYPICAL. TYPICAL. D'S TO BE COVERED BY A MINIMUM OF 3" CONCRETE. DE ALL REQUIRED COMPRESSION CONNECTIONS. BEBAR CONNECTION	TYPE KC TO PIPE				ILS	S 4-N DTA
WRAP GROUND LEAD IN HEAT SHRINK "A" - PARALLEL MOUNT "B" - PERP. MOUNT (SHOWN) WRAP GROUND LEAD IN HEAT SHRINK TAPE AT CONCRETE/GROUND INTERFACE TO PREVENT CORROSION PROPOSED #2 SOLID TINNED COPPER LEAD CONNECTED TO REBAR W/ MECHANICAL CLAMP; HARGER PART #RB12A/B (OR EQUIVALENT) PROPOSED GROUND ROD TYPICAL. TYPICAL. D'S TO BE COVERED BY A MINIMUM OF 3" CONCRETE. DE ALL REQUIRED COMPRESSION CONNECTIONS. BEBAR CONNECTION	OSSIBLE TYPES OF MECHANIC RD OR SPECIALLY DESIGNED (DE ALL REQUIRED MECHANICA	AL CONNECTIONS THAT GROUNDING PLANS. L CONNECTIONS.			IDING DETA	:: PORTIL : MS90XS /E, MINN
TYPICAL. PROPOSED BY A MINIMUM OF 3" CONCRETE. DE ALL REQUIRED COMPRESSION CONNECTIONS. REBAR CONNECTION BY A MINIMUM OF 3" CONCRETE. DE ALL REQUIRED COMPRESSION CONNECTIONS. BY A MINIMUM OF 3" CONCRETE. DE ALL REQUIRED COMPRESSION CONNECTIONS. BY A MINIMUM OF 3" CONCRETE. DE ALL REQUIRED COMPRESSION CONNECTIONS. BY A MINIMUM OF 3" CONCRETE. DE ALL REQUIRED COMPRESSION CONNECTIONS. BY A MINIMUM OF 3" CONCRETE. DE ALL REQUIRED COMPRESSION CONNECTIONS. BY A MINIMUM OF 3" CONCRETE. DE ALL REQUIRED COMPRESSION CONNECTIONS. BY A MINIMUM OF 3" CONCRETE. DE ALL REQUIRED COMPRESSION CONNECTIONS. BY A MINIMUM OF 3" CONCRETE. BY A MINIMUM OF 3" CONC	OUNDATION	HARGER P/N: RB12A/B "A" - PARALLEL MOUNT			GROUN	H K H
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REBAR CONNECTION TYPE FINAL CDS SHEET E_501	NS TO BE COVERED BY A MINI		PRO NUM	E JECT	172	258
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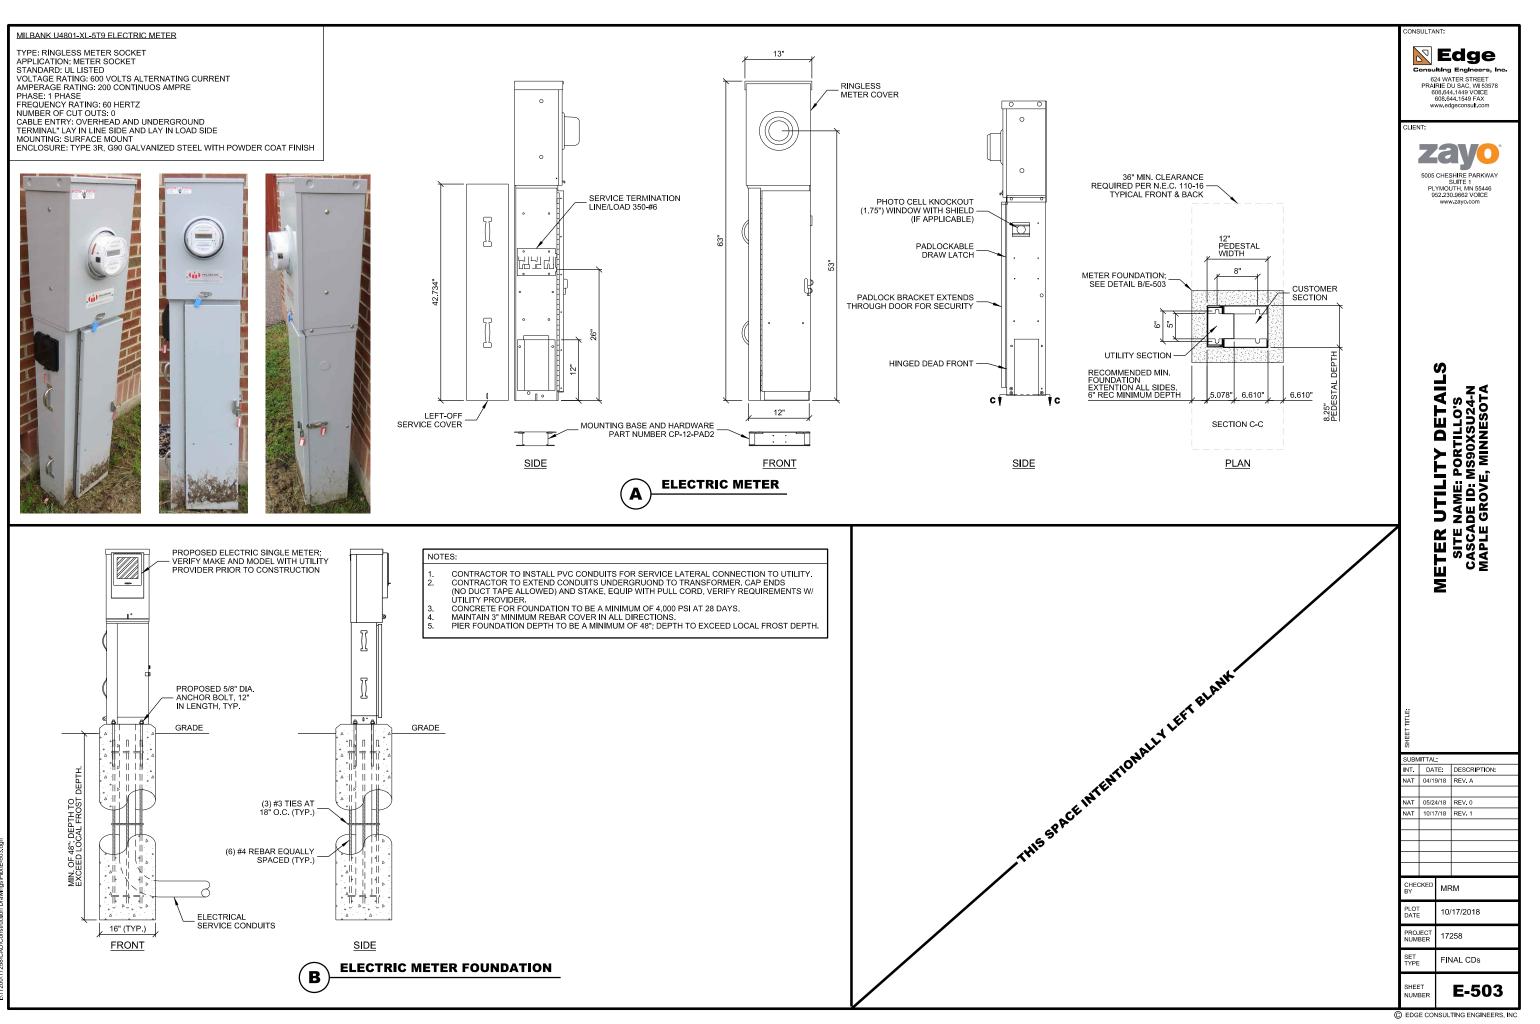


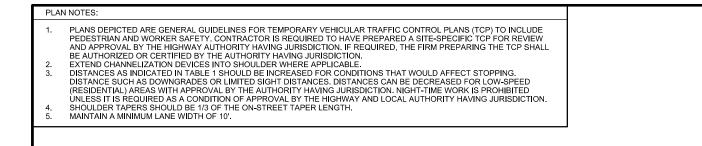
			CONSULTANT: ECONSULTANT: ECONSULTING Engineers, Inc. 624 WATER STREET PRAYEE DU SAC, WI 53578 608.644, 1549 FAX www.edgeconsult.com CLIENT:
N AH4400	AIRSPAN IR460	TOTAL	
E STATION	UE RELAY	N/A	5005 CHESHIRE PARKWAY SUITE 1
04	N/A	540	PLYMOUTH, MN 55446 952.230.9662 VOICE www.zayo.com
.50	N/A	4.50	
.54	N/A	0.54	
30.4	N/A	4730.4	
	ALCULATIONS		SHET TILE UTILITY DETAILS SITE NAME: PORTILLO'S CASCADE ID: MS90XSU24-N MAPLE GROVE, MINNESOTA
	ONAT		SUBMITTAL
TENT	ONAT		
EINTENT	onde		SUBMITTAL: INT. DATE: DESCRIPTION:
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Emperium	onde		SUBMITTAL: INT. DATE: DESCRIPTION: NAT 04/19/18 REV. A NAT 05/24/18 REV. 0 NAT 10/17/18 REV. 1 CHECKED MRM PLQT 40/15/20040
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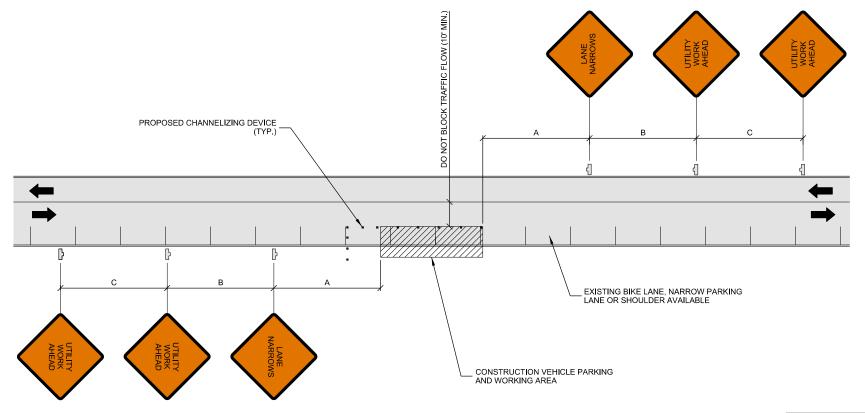



			TABLE 1			Ë			
POSTED SPEED (MPH)	DISTAN	CE BETWEE	N SIGNS	TAPER	BUFFER	SHEET ТІТLE:			
(1011-11)	А	В	С	L (SEE NOTE)	1		ITTAL:		
15	100'	100'	100'	45'	100'	INT.	DAT		DESCR
20	100'	100'	100'	80'	115'	NAT	04/19	/18	REV. A
25	100'	100'	100'	125'	155'	NAT	05/24	/18	REV.0
30	200'	200'	200'	180'	200'	NAT	10/17	/18	REV. 1
35	200'	200'	200'	245'	250'				
40	350'	350'	350'	320'	305'				
45	350'	350'	350'	540'	360'				
50	500'	500'	500'	600'	425'				
55	500'	500'	500'	660'	495'	CHEO	CKED	MF	RM
60	500'	500'	500'	720'	570'	BY			
65	500'	500'	500'	780'	645'	PLO1 DATE		10/	17/201
NOTES:						PRO.	IFCT		
1. DIS	TANCES IN F	EET UNLES	S OTHERWIS	E NOTED.		NUM		172	258
3. DIS	TANCES SHO	OWN ARE NO	XISTING SPE OT VALID FOR NUAL FOR DI	R LIMITED ACCESS	HIGHWAYS.	SET TYPE		FIN	NAL CI
4. AD. LOC	JUST DISTAN CAL HIGHWA	ICES TO COI Y AUTHORIT	MPLY WITH F	EQUIREMENT OF 1 IRISDICTION. SEE I LANE WIDTH. SEE	NOTE 1/D-502.	SHEE			D- :

c	Consulting Engineers, Inc. 624 WATER STREET PRAIRIE DU SAC, WI 53578 608.644.149 VOCE 608.644.1549 FAX www.edgeconsult.com						
	I	5005 PL	е ҮМОЦ 52.230	SHIRE PARKWAY SUITE 1 JTH, MN 55446 J3662 VOICE wzayo.com			
			TRAFFIC CONTROL PLAN	SITE NAME: PORTILLO'S CASCADE ID: MS90XSU24-N MAPLE GROVE, MINNESOTA			
	0 UBN NT.	ITTAL DA		DESCRIPTION:			
	AT	04/1		REV. A			
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s	SHEET NUMBER D-501						

ONSULTANT

TRAFFIC CONTROL GENERAL NOTES

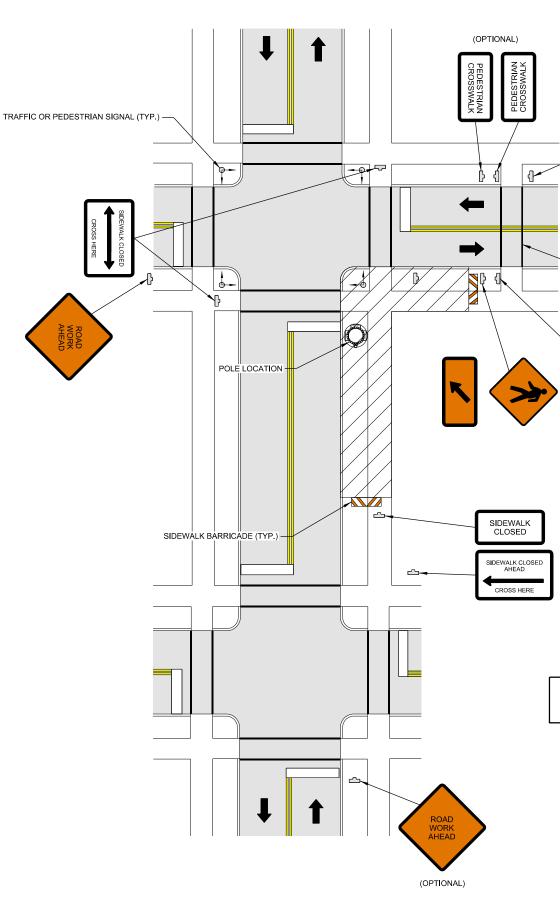- ALL TEMPORARY TRAFFIC CONTROL SIGNAGE, LAYOUTS AND PROCEDURES SHALL COMPLY WITH LOCAL 1. JURISDICTIONAL REQUIREMENTS AND MANUAL OF UNIFORM TRAFFIC CONTROL DEVICES (MUTCD), LATEST EDITION, WHICHEVER IS MORE STRINGENT.
- EDITION, WHICHEVEN IS MORE STRINGENT. PRIOR TO ANY ROAD CONSTRUCTION, TRAFFIC CONTROL SIGNS AND DEVICES SHALL BE IN PLACE. TRAFFIC CONTROL DEVICES FOR LANE CLOSURES INCLUDING SIGNS, CONES, BARRICADES, ETC. SHALL BE PLACED AS SHOWN ON PLANS. SIGNS SHALL NOT BE PLACED WITHOUT ACTUAL LANE CLOSURES AND SHALL BE IMMEDIATELY REMOVED UPON REMOVAL OF THE CLOSURES. SELECTION, PLACEMENT, MAINTENANCE, AND PROTECTION OF TRAFFIC, PEDESTRIANS, AND WORKERS
- SHALL BE IN ACCORDANCE WITH THE MANUAL OF UNIFORM TRAFFIC CONTROL DEVICES (MUTCD) PART VI "TEMPORARY TRAFFIC CONTROL", AND LOCAL JURISDICTIONAL REQUIREMENTS UNLESS OTHERWISE NOTED IN THE PLANS AND SPECIFICATIONS, AND SHALL BE APPROVED BY THE APPROPRIATE HIGHWAY AUTHORITY HAVING JURISDICTION.
- ADVANCE WARNING SIGNS, DISTANCES, AND TAPER LENGTHS MAY BE EXTENDED TO ADJUST FOR REDUCED VISIBILITY DUE TO HORIZONTAL AND VERTICAL CURVATURE OF THE ROADWAY AND FOR ACTUAL TRAFFIC SPEEDS IF IN EXCESS OF POSTED SPEED LIMITS. TAPERS SHALL BE LOCATED TO MAXIMIZE THE VISIBILITY OF THEIR TOTAL LENGTH. CONFLICTING OR NON-OPERATING SIGNAL INDICATIONS ON THE EXISTING TRAFFIC SIGNAL SYSTEMS SHALL
- BE BAGGED OR COVERED. ALL EXISTING ROAD SIGNS, PAVEMENT MARKINGS AND/OR PLOWABLE PAVEMENT REFLECTORS WHICH
- 8. CONFLICT WITH THE PROPOSED TRAFFIC CONTROL PLAN SHALL BE COVERED, REMOVED, OR RELOCATED. ALL TRAFFIC CONTROL DEVICES SHALL BE RESTORED TO MATCH PRE-CONSTRUCTION CONDITION AFTER
- ALL TRAFFIC CONTROL DEVICES SHALL BE RESTORED TO MATCH PRE-CONSTRUCTION CONDITION AFTER COMPLETION OF WORK. CONTRACTOR SHALL CONTACT LOCAL AUTHORITY HAVING HIGHWAY JURISDICTION AND PROVIDE ADDITIONAL "FLAGMEN" OR POLICE SUPERVISION, IF REQUIRED. ALL EXCAVATED AREAS WITHIN OR ADJACENT TO THE ROADWAY SHALL BE BACKFILLED AND PLACED ON A MINIMUM 6H:1V SLOPE PRIOR TO END OF EACH WORK DAY. OTHER EXCAVATED AREAS WITHIN THE CLEAR ZONE ARE TO BE EITHER BACKFILLED OR PRECAST CONCRETE CURB BARRIER CONSTRUCTION BARRIER SET TEMPORARILY IN PLACE TO SHIELD VEHICULAR AND PEDESTRIAN TRAFFIC. WHERE DICTATED BY LOCAL CONDITIONS, THE CONTRACTOR SHALL MAKE PROVISIONS FOR MAINTAINING PEDESTRIAN AND WORKER CROSSING LOCATIONS IN ACCORDANCE WITH ALL APPLICABLE CODES AND OSHA BRED URDENTS. 10.
- 11.
- PEDESTRIAN AND WORKER CROSSING LOCATIONS IN ACCORDANCE WITH ALL AFFLICABLE CODES AND OSHA REQUIREMENTS. CONSTRUCTION ZONE SPEED LIMIT IF REDUCED FROM POSTED LIMITS SHALL BE IN ACCORDANCE WITH MUTCD AND WILL BE DETERMINED BY THE AUTHORITY HAVING JURISDICTION. THERE SHALL BE NO WORKERS, EQUIPMENT, OR OTHER VEHICLES IN THE BUFFER SPACE OR THE ROLL AUTAD SPACE 12. 13.
- AHEAD SPACE DRIVEWAYS AND/OR SIDE STREETS ENTERING THE ROADWAY AFTER THE FIRST ADVANCE WARNING SIGN 14.
- SHALL BE PROVIDED WITH AT LEAST ONE W20-1 SIGN (ROAD WORK AHEAD) AS A MINIMUM. CONES MAY BE SUBSTITUTED FOR DRUMS AND INSTALLED UPON THE APPROVAL OF THE AUTHORITY HAVING JURISDICTION PROVIDED THEY COMPLY WITH MUTCD. 15.
- 16.
- THE SPACING BETWEEN CONES, TUBULAR MARKERS, VERTICAL PANELS, DRUMS, AND BARRICADES SHOULD NOT EXCEED A DISTANCE IN FEET EQUAL TO 1.0 TIMES THE SPEED LIMIT IN MPH WHEN USED FOR TAPER CHANNELIZATION, AND A DISTANCE IN FEET EQUAL TO 2.0 TIMES THE SPEED LIMIT IN MPH WHEN USED FOR TANGENT CHANNELIZATION.
- TANGENT CHANNELIZATION. WHEN CHANNELIZATION DEVICES HAVE THE POTENTIAL OF LEADING VEHICULAR TRAFFIC OUT OF THE INTENDED VEHICULAR TRAFFIC SPACE, THE CHANNELIZATION DEVICES SHOULD BE EXTENDED A DISTANCE IN FEET OF 2.0 TIMES THE SPEED LIMIT IN MPH BEYOND THE DOWNSTREAM END OF THE TRANSITION AREA. TAPER LENGTHS ARE CALCULATED AS FOLLOWS: L= WS²/60 (40 MPH AND HIGHER) OR L2= WS (OVER 40 MPH), WHERE W= OFFSET WIDTH (FT), S= TRAFFIC SPEED (MPH). 17. 18.



	CONSULTANT:
TEMPORARY MARKING FOR CROSSWALK LINES (CROSS-HATCHING OPTIONAL)	PEDESTRIAN SAFETY PLAN SITE NAME: PORTILLO'S CASCADE ID: MS90XSU24-N MAPLE GROVE, MINNESOTA
PROVIDE PEDESTRIAN/WORKER SAFETY CONTROL DEVICES IF REQUIRED	iii iii SUBMITTAL: DESCRIPTION: INT. DATE: DESCRIPTION: NAT 04/19/18 REV. A NAT 05/24/18 REV. 0 NAT 10/17/18 REV. 1 NAT 10/17/18 REV. 1 Image: Stress of the stress
	SET TYPE FINAL CDs SHEET NUMBER D-502