

# VERIZON WIRELESS

# MINC RUSH CREEK COLO

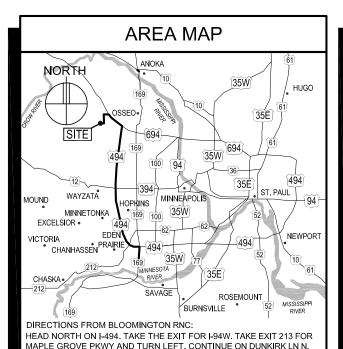

TURN RIGHT ONTO 89TH AVE N. TURN RIGHT ONTO LAWNDALE LN N.

SITE WILL BE ON YOUR LEFT, BEHIND THE FIRE STATION.

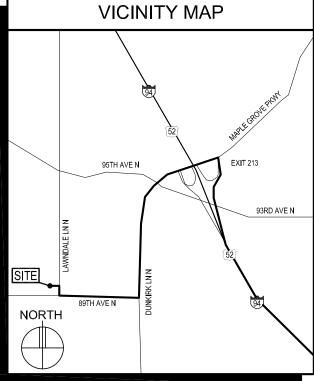

## **GENERAL NOTES**

- In the event that Special Inspections are not performed in compliance with the contract terms, bid specifications and/or specified form, the General Contractor will be liable for all damages, construction performance, failures, and corrective actions related to the same.
- The following general notes shall apply to drawings and govern unless otherwise noted or specified
- The work delineated in these drawings and described in the specifications shall conform to codes, standards and regulations that have jurisdiction in the state of MINNESOTA , and the city of MAPLE GROVE.
- Requirements and regulations pertaining to R.F. safety codes and practices must be incorporated in the work even though they may not be listed individually and separately in either the drawings or the specifications.
- Compare field conditions with architectural and engineering drawings. Any discrepancies shall be directed to the Architect for clarification prior to fabrication and/or construction. Submit necessary shop drawings prior to fabrication for approval by the Architect. No information or details on these sheets may be used without the permission of the owner, or the architect
- Do not scale drawings! 11" x 17" drawings to scale
- Unless otherwise shown or noted, typical details shall be used where applicable.
- Details shall be considered typical at similar conditions.
- Safety measures: The contractor shall be solely and completely responsible for the conditions of the job site, including safety of the persons and property and for independent engineering reviews of these conditions. The Architect's or Engineers' job site review is not intended to include review of the adequacy
- Within these plans and specifications, "Owner" implies VERIZON WIRELESS.
- The work is the responsibility of the general contractor unless noted otherwise.
- The terms "contractor" and "g.c." refer to the owner's general contractor and the general contractor's sub-contractors. It is the general contractor's responsibility to determine the division of work among sub-contractors.
- The general contractor is responsible in obtaining necessary public and private underground utility locate services prior to start of excavating / construction.

# **VERIZON WIRELESS DEPARTMENTAL APPROVALS**

	NAME	DATE
RF ENGINEER	JORDAN ALSTAD	05-20-14 1
OPERATIONS MANAGER	DAVID COX	05-27-14
CONSTRUCTION ENGINEER	STEVE COLLIN	05-30-14
CONSTRUCTION MANAGER		
REAL ESTATE MANAGER		

## LESSOR / LICENSOR APPROVAL

SIGNATURE	PRINTED NAME	DATE
PDF	CHAD HILTNER	06-10-14
LESSOR / LICENSOR: PLEASE CHECK THE APPROPRIATE BOX BELOW		
X NO CHANGES.	HANGES NEEDED. SEE COMMEN	TS ON PLANS.

## PROJECT INFORMATION

SITE NAME MINC RUSH CREEK

PROJECT NUMBER 20130877266 SITE ADDRESS: 8925 I AWNDALE AVE

MAPLE GROVE, MN 55311

1039.2' AMSL - 87.0' AGL

COUNTY: HENNEPIN

LATITUDE: N45° 07' 02 046" (NAD83) ONGITUDE W93° 30' 11.912" (NAD83) GROUND ELEVATION 952.2' AMSL (NAVD88) ANTENNA TIP HEIGHT:

ANTENNA CENTERLINE HEIGHT: 1035.2' AMSL - 83.0' AGL

TOWER HEIGHT 1052 2' AMSL - 100.0' AGL

OVERALL STRUCTURE HEIGHT: 1056.2' AMSL - 104.0' AGL

DRAWING BASED ON SITE DATA FORM DATED:

OCCUPANCY

BUILDING TYPE

SITE AREA 9' X 11' = 99 SF

PARKING PROVIDED

ESTIMATED COAX RUN: "X" COAX RUN = (2) 1-5/8" LINES @ 150' EA

01-03-17

"Y" COAX RUN = (2) 1-5/8" LINES @ 150' EA "Z" COAX RUN = (2) 1-5/8" LINES @ 150' EA

PROJECT DESCRIPTION:

INSTALL THE PROPOSED SHELTER IN THE EXISTING COMPOUND AND PROPOSED ANTENNAS ON THE EXISTING MONOPOLE TOWER TO IMPROVE COMMUNICATION SERVICE IN THE MAPLE GROVE, MN AREA.

SHEET INDEX			
SHEET	SHEET DESCRIPTION		
T-1	PROJECT INFORMATION, MAPS, DIRECTIONS, AND SHEET INDEX		
A-1, A-1.1	SITE PLAN & TEMPORARY CONSTRUCTION PLAN		
A-2	ENLARGED SITE PLAN		
A-2.1	GRADING PLAN, PLANTING DETAIL		
1.3	TOWER ELEVATION, COAX AND ANTENNA KEY, NOTES, AND DETAILS		
A-4, A-4.2	SHELTER PLANS, ELEVATIONS, NOTES, & DETAILS		
A-0	MISCELLANEOUS DETAILS		
A-6	OUTLINE SPECIFICATIONS		
G-1	GROUNDING NOTES AND DETAILS		
G-2	GROUNDING PLAN AND NOTE KEY		
G-3	EXTERIOR GROUNDING DETAILS		
U-1	UTILITY PLAN, NOTES, AND DETAILS		
<u> </u>	ENVIROBUILDING DRAWINGS REMOVED FROM SUBMITTAL $1$		
E-1/E-7	ELECTRICAL PLAN, NOTES, AND DETAILS		
S1 & S2	SURVEY		

ISSUE SUMMARY		
REV.	DESCRIPTION	SHEET OR DETAIL
G	CITY CMTs, SDF UPDATE, GATE ADD 03-14-17	T-1:A-6, G-2:U-1, ELEC, SURVEY
H	CITY COMMENTS, REVISED SURVEY 05-01-17	T-1 A-3 A-5 A-6

SURVEY A-5, A-6 G-2, SURVEY REVISED ACCESS DRIVE, APPROACH A-1, A-2, A-2.1, & GROUNDING 08-02-17 ACCESS EASEMENT 10-18-17 T-1, A-1, A-2, SURVEY ISSUED FOR BID/CONSTRUCTION 02-07-18 ALL **BUILDING DEPARTMENT REVISIONS 06-08-18** T & A

#### CONTACTS

LESSOR / LICENSOR **CROWN CASTLE** 

2000 CORPORATE DRIVE CANONSBURG PA 15317

LESSEE: **VERIZON WIRELESS** 

10801 BUSH LAKE ROAD BLOOMINGTON, MN 55438 RON REITER (612) 720-0052

POWER UTILITY XCEL ENERGY COMPANY CONTACT:

BOX 9477

MINNEAPOLIS, MN 55484

JASON DARRINGTON 763-493-1854

TELCO UTILITY COMPANY CONTACT:

ARCHITECT: DESIGN 1 OF EDEN PRAIRIE, LLC.

9973 VALLEY VIEW ROAD EDEN PRAIRIE, MN 55344

(952) 903-9299

320-762-8149

WIDSETH SMITH NOLTING SURVEYOR:


610 FILLMORE ST, PO BOX 1028 ALEXANDRIA, MN 56308

**CROWN CASTLE** STRUCTURAL

2000 CORPORATE DRIVE ENGINEER: CANONSBURG, PA 15317

GEOTECHNICAL N/A ELECTRICAL BUSSELL COMPANIES, INC. 16026 MINNETONKA BLVD. ENGINEER:

SUITE 100 MINNETONKA, MN 55345 PHONE: (952) 931-2111

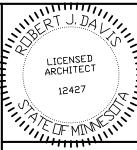

I hereby certify that this plan specification or report was prepared by me or under my direct supervision and that I am a duly registered Architect under the laws of the State of Minnesota ROBERT J. DAVIS, Reg. No. 1242





9973 VALLEY VIEW RD. EDEN PRAIRIE, MN 55344 WWW DESIGN1EP COM

# **VERIZON WIRELESS**

10801 BUSH LAKE ROAD BLOOMINGTON, MN 55438

**PROJECT** 20130877266 LOC. CODE: 265758


MINC **RUSH CREEK CROWN CASTLE** BU #825666


8925 LAWNDALE AVE MAPLE GROVE, MN 5531

#### SHEET CONTENTS:

CONTACTS ISSUE SUMMARY SHEET INDEX DEPARTMENTAL APPROVALS LESSOR APPROVAL PROJECT INFORMATION AREA & VICINITY MAPS **GENERAL NOTES** 

DRAWN BY:	TR
DATE:	08-02-
CHECKED BY:	CE
REV. G	03-14-
REV. H	05-01-
REV. J	08-02-
REV. K	10-18-
REV.0	02-07-
REV.1	06-08-

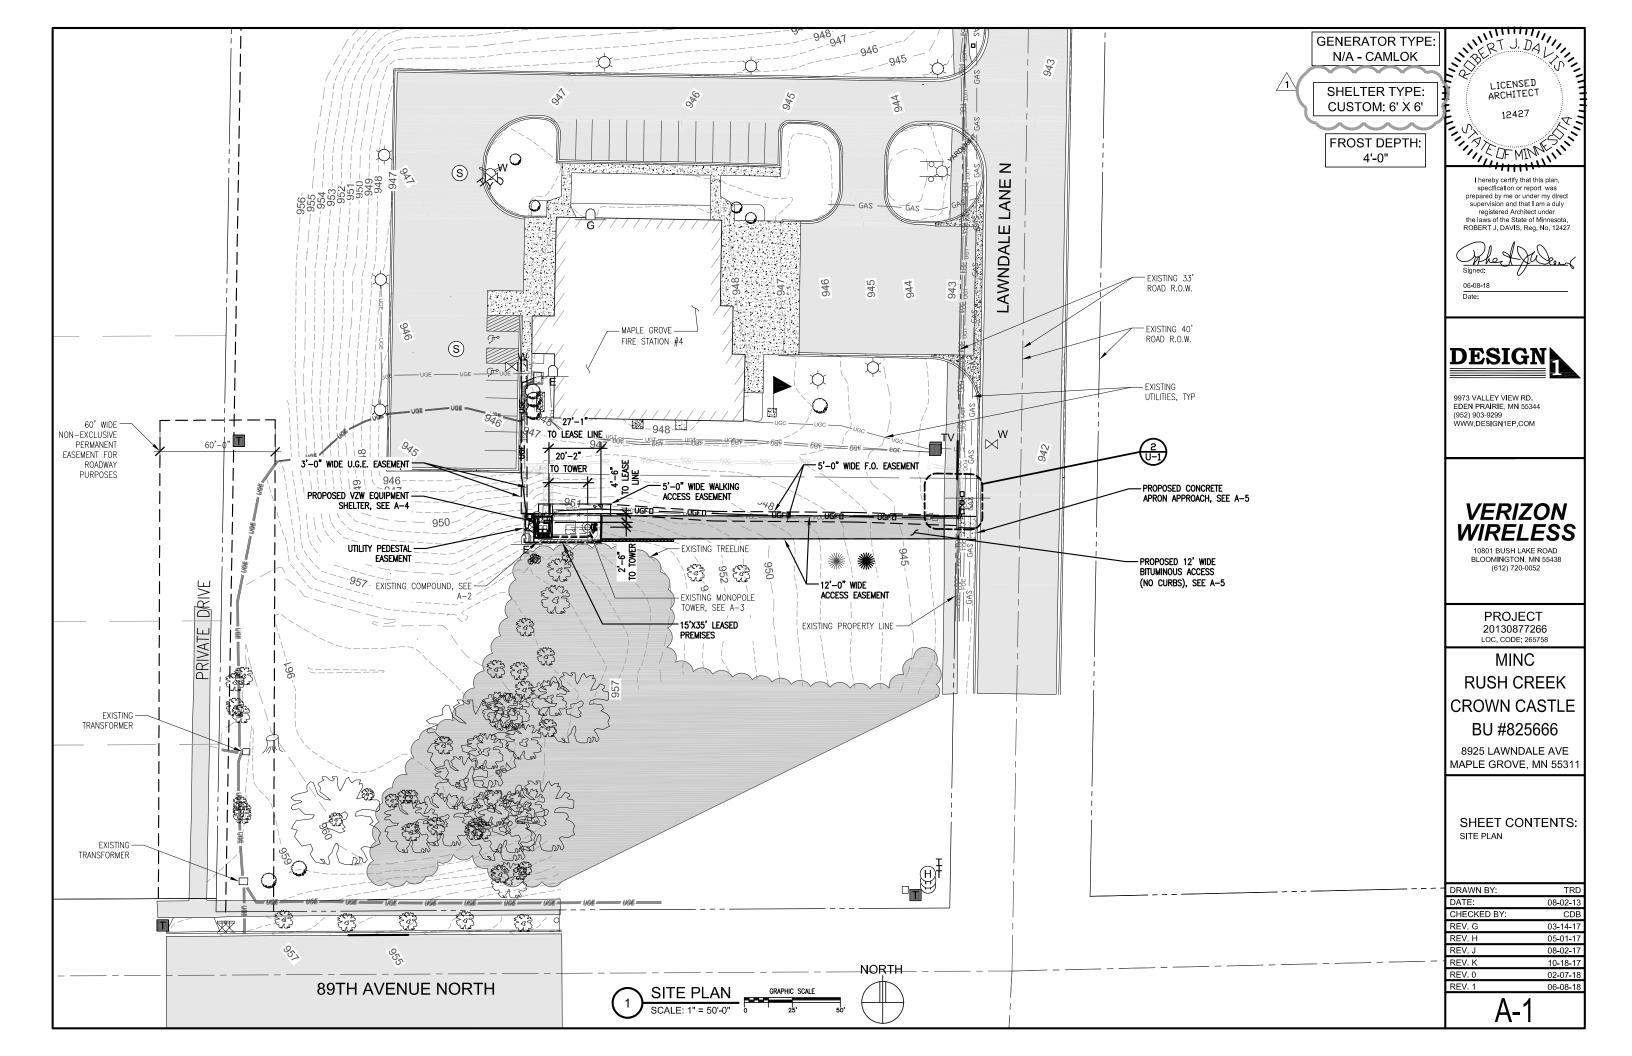

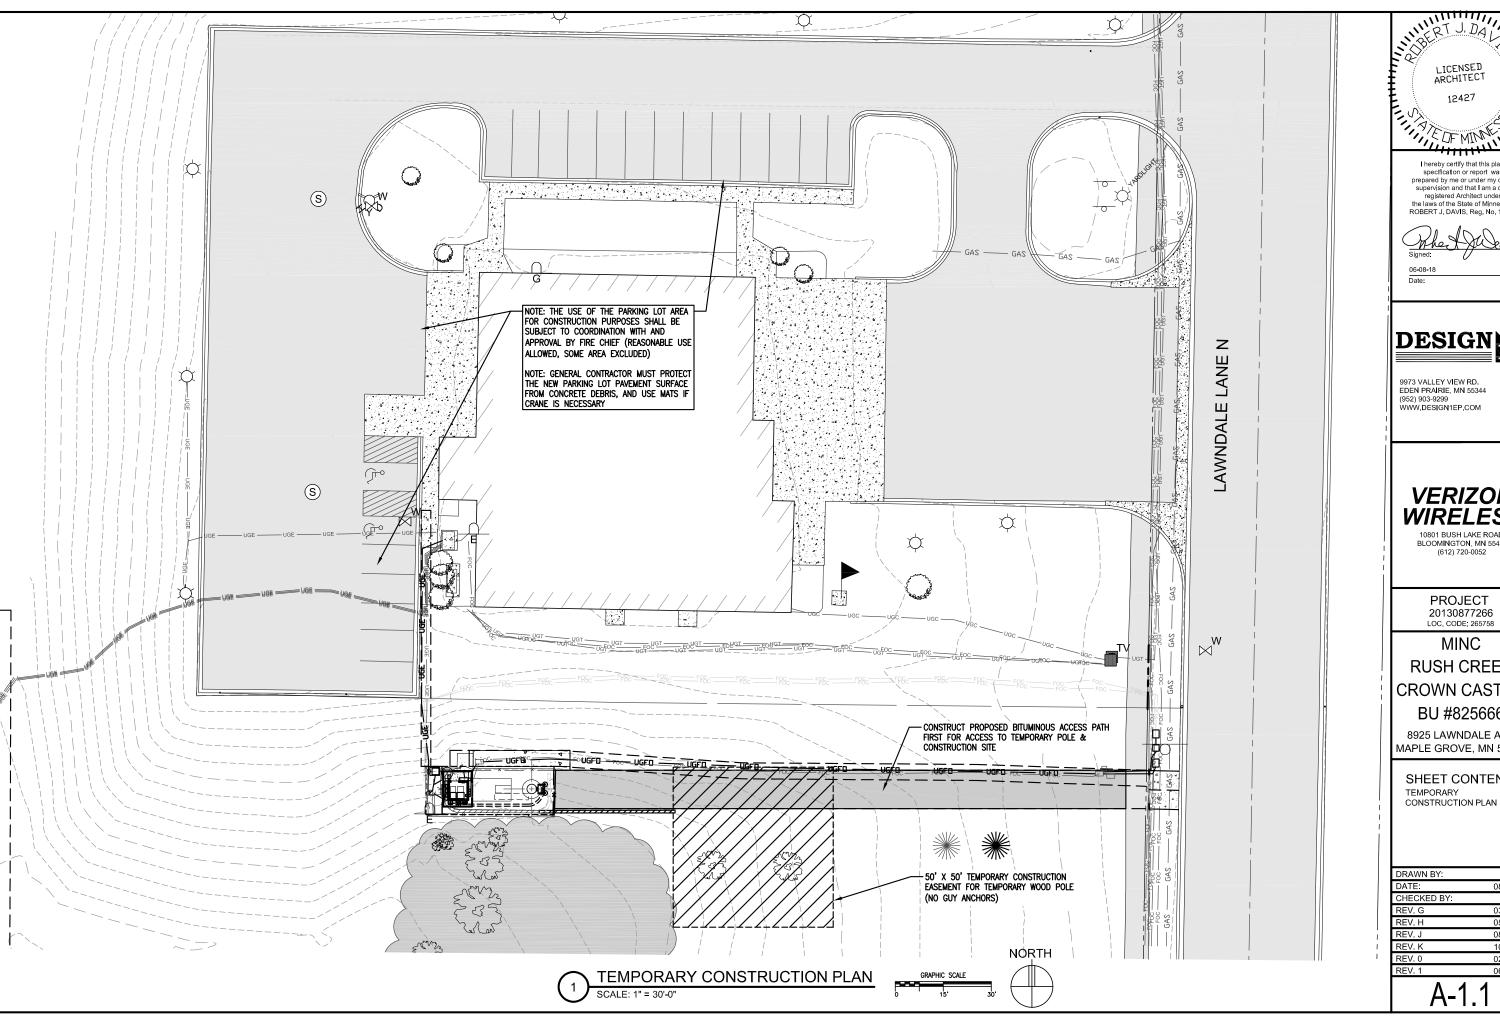

LICENSED ARCHITECT 12427 STE OF MONT

I hereby certify that this plan, specification or report was prepared by me or under my direct supervision and that I am a duly registered Architect under the laws of the State of Minnesota, ROBERT J. DAVIS, Reg. No. 12427

# DESIGN

9973 VALLEY VIEW RD. EDEN PRAIRIE, MN 55344 (952) 903-9299 WWW.DESIGN1EP.COM

# **VERIZON WIRELESS**

10801 BUSH LAKE ROAD BLOOMINGTON, MN 55438 (612) 720-0052


PROJECT 20130877266 LOC. CODE: 265758


# MINC **RUSH CREEK** CROWN CASTLE BU #825666


8925 LAWNDALE AVE MAPLE GROVE, MN 55311

SHEET CONTENTS:

DRAWN BY:	TRD
DATE:	08-02-13
CHECKED BY:	CDB
REV. G	03-14-17
REV. H	05-01-17
REV. J	08-02-17
REV. K	10-18-17
REV. 0	02-07-18
DEV 4	00 00 40

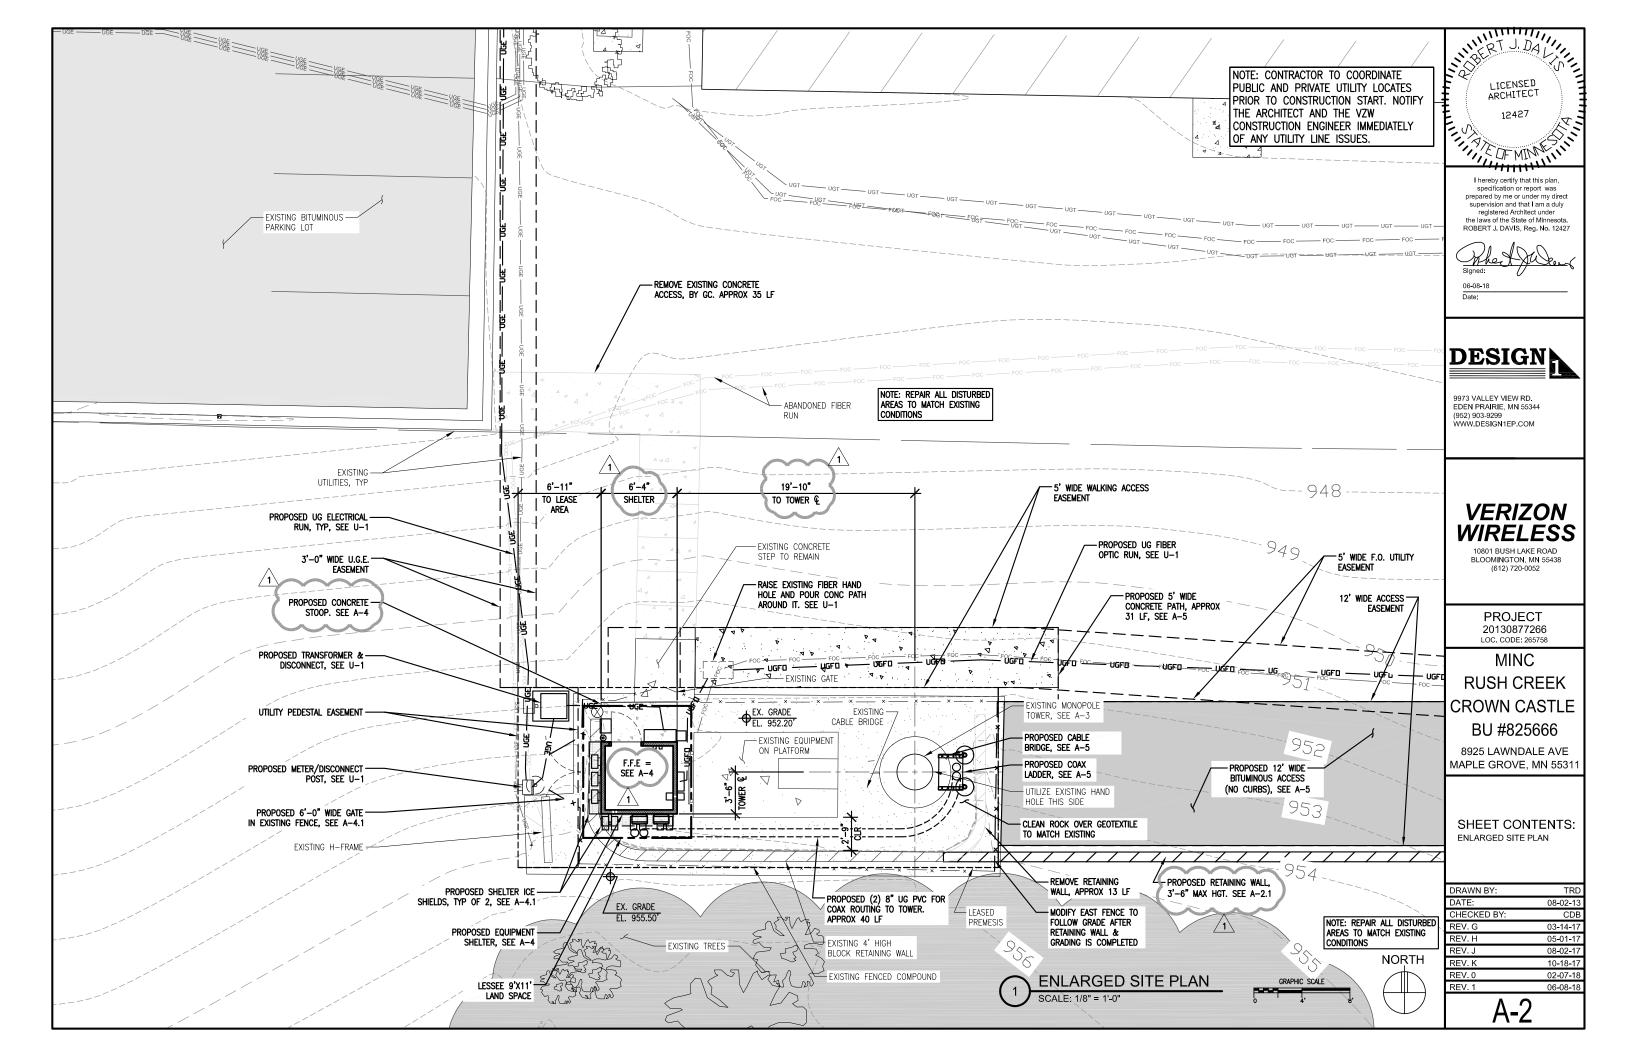

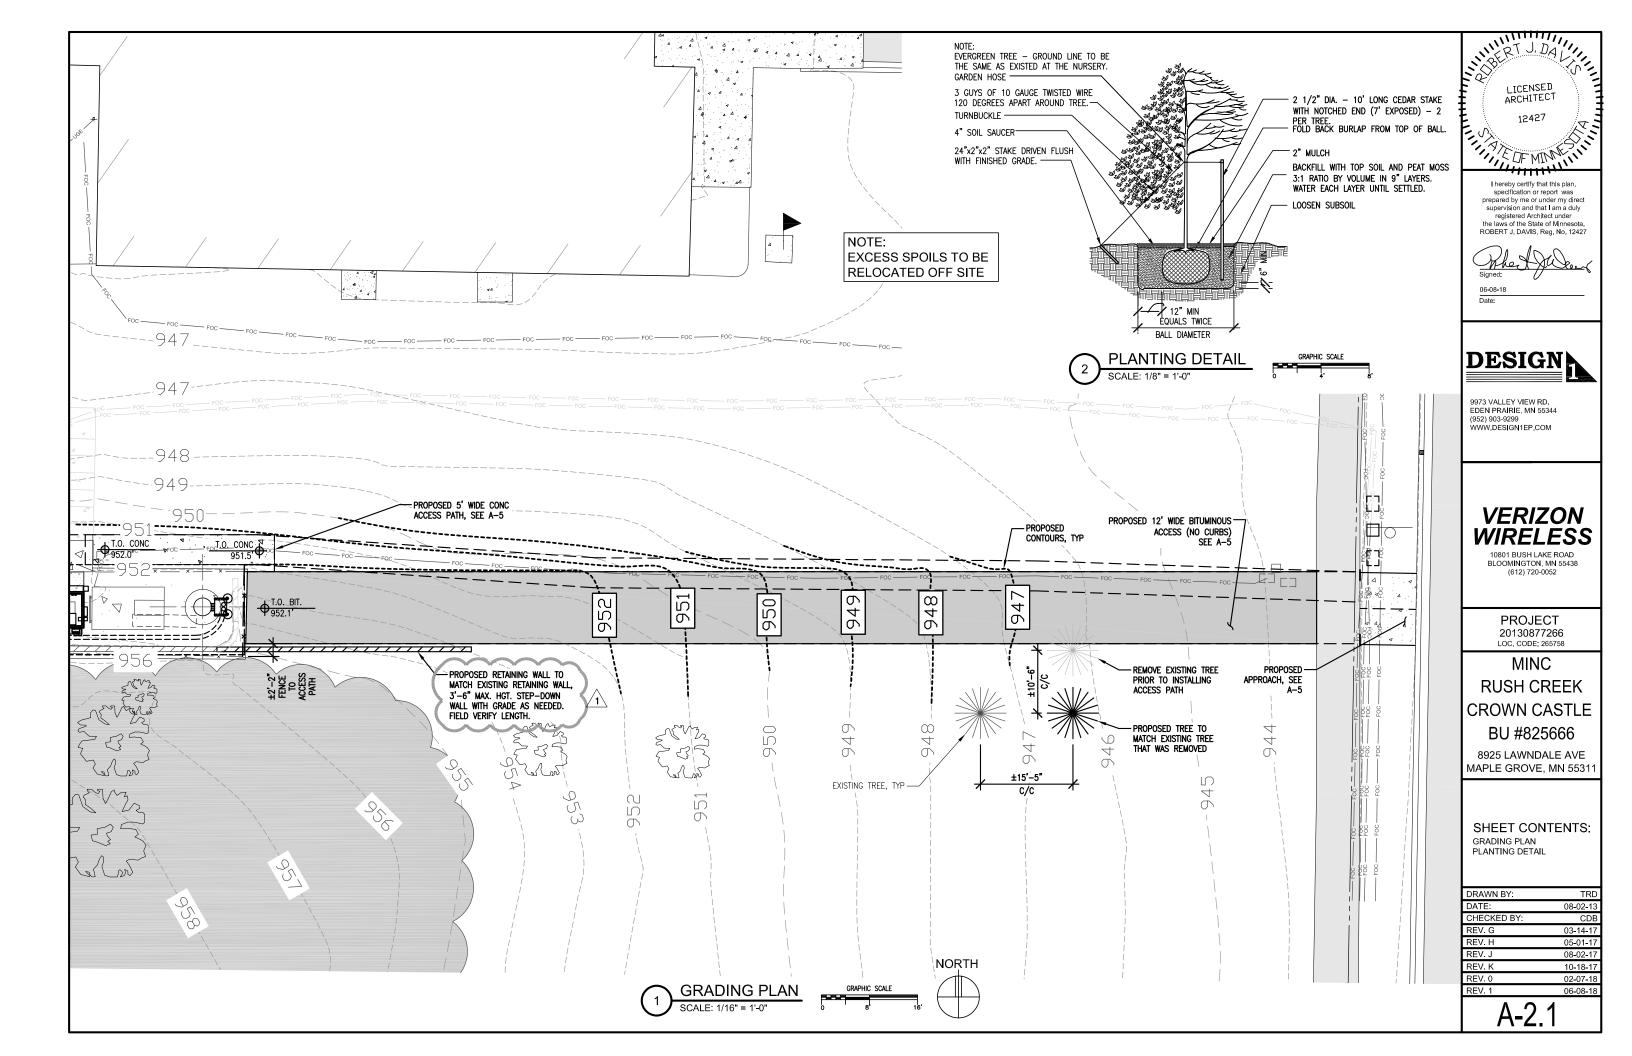

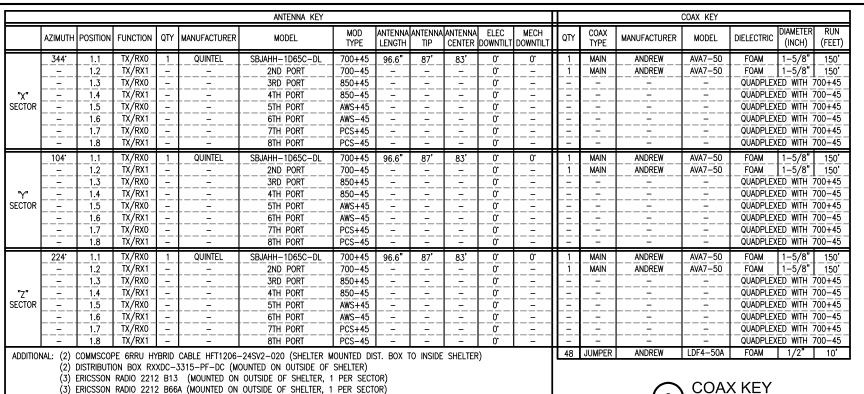

'X' SECTOR 344: AZIMUTH #1.1/1.2 700 #1.3/1.4 850 1.5/1.6 AWS QUADPLEXERS MOUNTED -BACK-TO-BACK BELOW ANTENNA TYP OF 2 PER SECTOR QUINTEL TRI-SECTOR MOUNT KIT, MODEL# AS0093 NORTH ANTENNA MOUNTING DETAIL

OVERALL STRUCTURE HEIGHT

1056.2' AMSL / 104.0' AGL

1052.2' AMSL / 100.0' AGL

EXISTING ANTENNA C HEIGHT 1049.2' AMSL / 97.0' AGL

EXISTING ANTENNA & HEIGHT 1043.2' AMSL / 91.0' AGL

VZW ANTENNA TIP HEIGHT

1039.2' AMSL / 87.0' AGL

1035.2' AMSL / 83.0' AGL

NOTE: THESE DRAWINGS WERE PREPARED BASED

ON INFORMATION SUPPLIED IN THE STRUCTURAL

MODIFICATION REPORT DATED 02/23/17 BY

GPD GROUP, PROJECT# 2017777.825666.02.

NOTIFY THE AUTHOR OF THE REPORT AND

NOTE: CONTRACTOR TO VERIFY TOWER

MODIFICATIONS REFERENCED IN TOWER

OTHERS PRIOR TO INSTALLING PROPOSED

(6) PROPOSED COAX CABLES -

ROUTE INSIDE OF TOWER

UTILIZE EXISTING HAND HOLE -

PROPOSED CABLE BRIDGE,

PROPOSED PVC CONDUIT -

NORTH ELEVATION

SEE A-5

VZW EQUIPMENT & RELATED HARDWARE

STUDY HAVE BEEN COMPLETED BY

DESIGN 1 OF ANY DISCREPANCIES CONTAINED HEREIN FOR THE ANTENNAS, QUADPLEXERS &

, vzw antenna & Height

FEEDLINE INSTALLATION.

GRADE @ TOWER

SCALE: 1" = 20'

TOWER HEIGHT

prepared by me or under my direct supervision and that I am a duly registered Architect under the laws of the State of Minnesota ROBERT J. DAVIS, Reg. No. 12427

RT J. DAL

LICENSED

ARCHITECT

12427

EDFMINE

I hereby certify that this plan

specification or report was

DESIGN

EXISTING ANTENNAS

(OTHER PROVIDER,

PROPOSED

(3) ANTENNAS

EXISTING 100'

GALV STEALTH

NOTE: EXISTING

SEE A-4

GRAPHIC SCALE

EQUIPMENT & FENCE

NOT SHOWN FOR CLARITY

- PROPOSED SHELTER,

MONOPOLE TOWER

(6) QUADPLEXERS (INSIDE 10' CANISTER)

INSIDE 12' CANISTERS)

EDEN PRAIRIE, MN 55344

(952) 903-9299 WWW.DESIGN1EP.COM

# **VERIZON WIRELESS**

10801 BUSH LAKE ROAD BLOOMINGTON, MN 55438 (612) 720-0052

> **PROJECT** 20130877266 LOC. CODE: 265758

MINC **RUSH CREEK CROWN CASTLE** 

8925 LAWNDALE AVE MAPLE GROVE, MN 55311

BU #825666


#### SHEET CONTENTS:

TOWER ELEVATION COAX & ANTENNA KEY **GPS DETAIL & ELEVATION** ANTENNA MOUNTING DETAIL COAX ENTRY DETAIL

DRAWN BY:	TRD
DATE:	08-02-13
CHECKED BY:	CDB
REV. G	03-14-17
REV. H	05-01-17
REV. J	08-02-17
REV. K	10-18-17
REV. 0	02-07-18
REV 1	06-08-18

**A-3** 


**COAX KEY** 

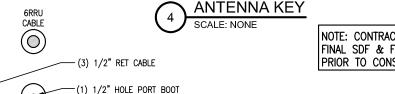



NOTE: CONTRACTOR TO OBTAIN CURRENT FINAL SDF & FAA DETERMINATION FROM VZW PRIOR TO CONSTRUCTION COMMENCEMENT

SCALE: 3/4" = 1'-0"

NOTE:
THE ARCHITECT MAKES NO WARRANTY, EXPRESSED OR IMPLIED, OF THE ACCURACY OF THE STRUCTURAL ANALYSIS AND THE PERFORMANCE OF THE COMPLETED CONSTRUCTION AS SHOWN ON THESE DOCUMENTS AND THE STRUCTURAL ANALYSIS.

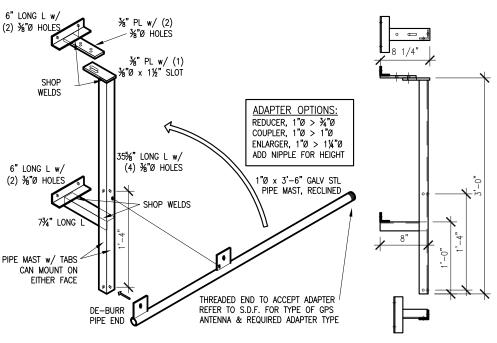

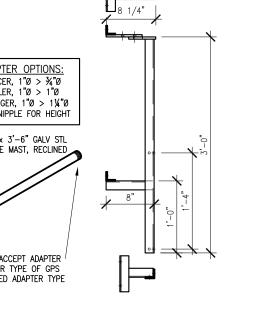

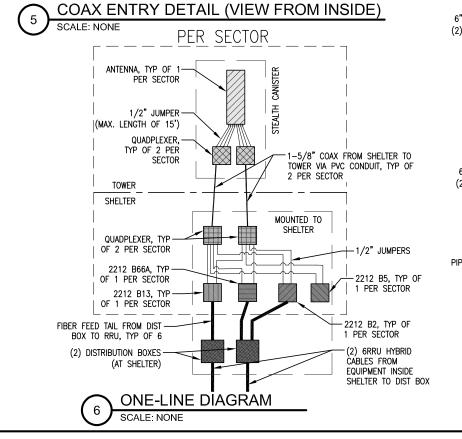

(3) ERICSSON RADIO 2212 B2 (MOUNTED ON OUTSIDE OF SHELTER, 1 PER SECTOR)

(MOUNTED ON OUTSIDE OF SHELTER, 1 PER SECTOR)

(6) COMMSCOPE HYBRID JUMPER HFT410-4SVHY-15 (FIBER FEED TAIL SHELTER MOUNTED DIST. BOX TO RRU)

FÓR GPS COAX


(12) COMMSCOPE QUADPLEXER E15V90P46 (6 MOUNTED ON OUTSIDE OF SHELTER, 6 MOUNTED IN TOWER, 2 PER SECTOR)

(3) ERICSSON RADIO 2212 B5

CABLE


 $\bigcirc$ 



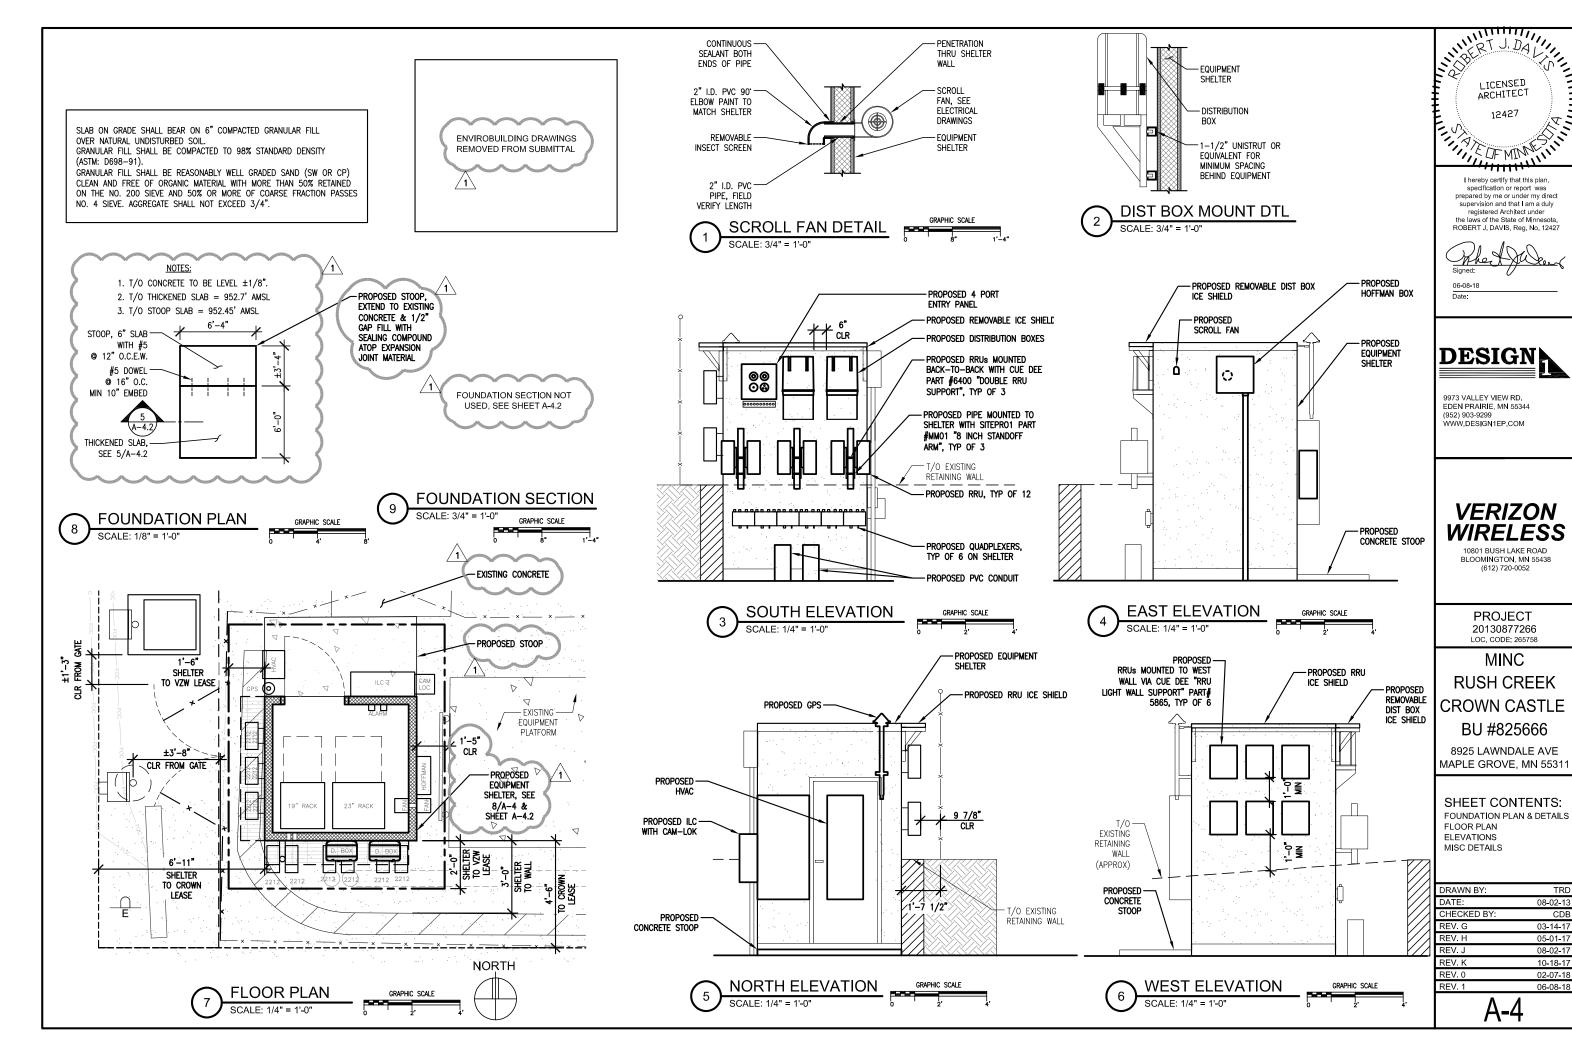

TRE

CDF

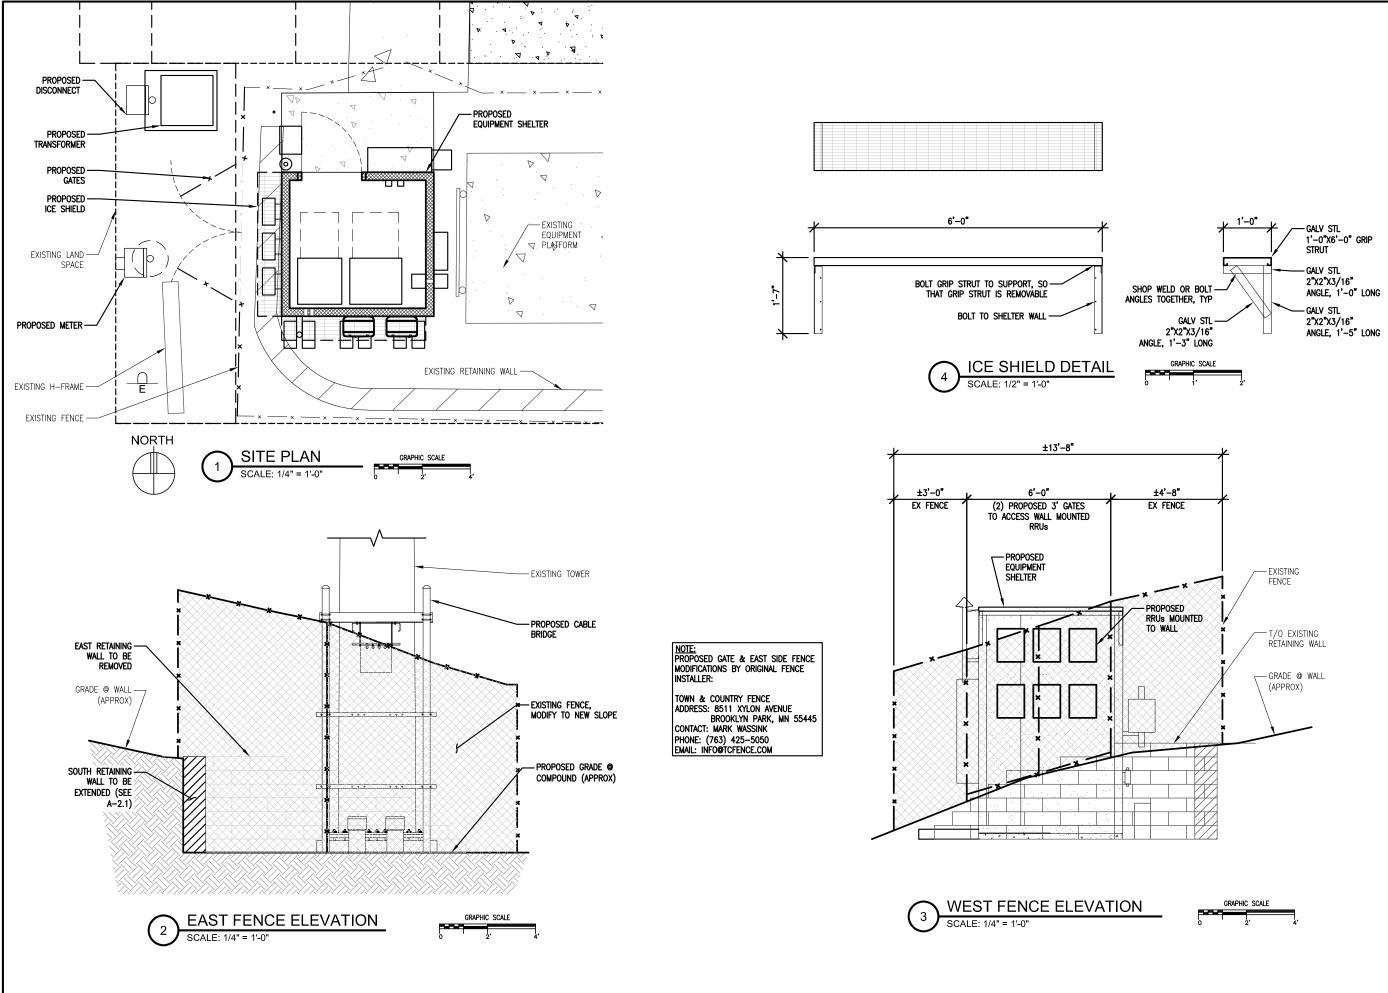

LICENSED ARCHITECT
12427

DF MINN

I hereby certify that this plan, specification or report was prepared by me or under my direct supervision and that I am a duly registered Architect under the laws of the State of Minnesota. ROBERT J. DAVIS, Reg. No. 12427

The Jule ...
Signed:
06-08-18

06-08-18 Date:



9973 VALLEY VIEW RD. EDEN PRAIRIE, MN 55344 (952) 903-9299 WWW.DESIGN1EP.COM

# VERIZON WIRELESS

10801 BUSH LAKE ROAD BLOOMINGTON, MN 55438 (612) 720-0052

> PROJECT 20130877266 LOC. CODE: 265758

MINC RUSH CREEK CROWN CASTLE BU #825666


8925 LAWNDALE AVE MAPLE GROVE, MN 5531

#### SHEET CONTENTS:

FENCE DETAILS ICE SHIELD DETAIL

DRAWN BY:	TRD
DATE:	08-02-13
CHECKED BY:	CDB
REV. G	03-14-17
REV. H	05-01-17
REV. J	08-02-17
REV. K	10-18-17
REV. 0	02-07-18
REV. 1	06-08-18

A-4.1

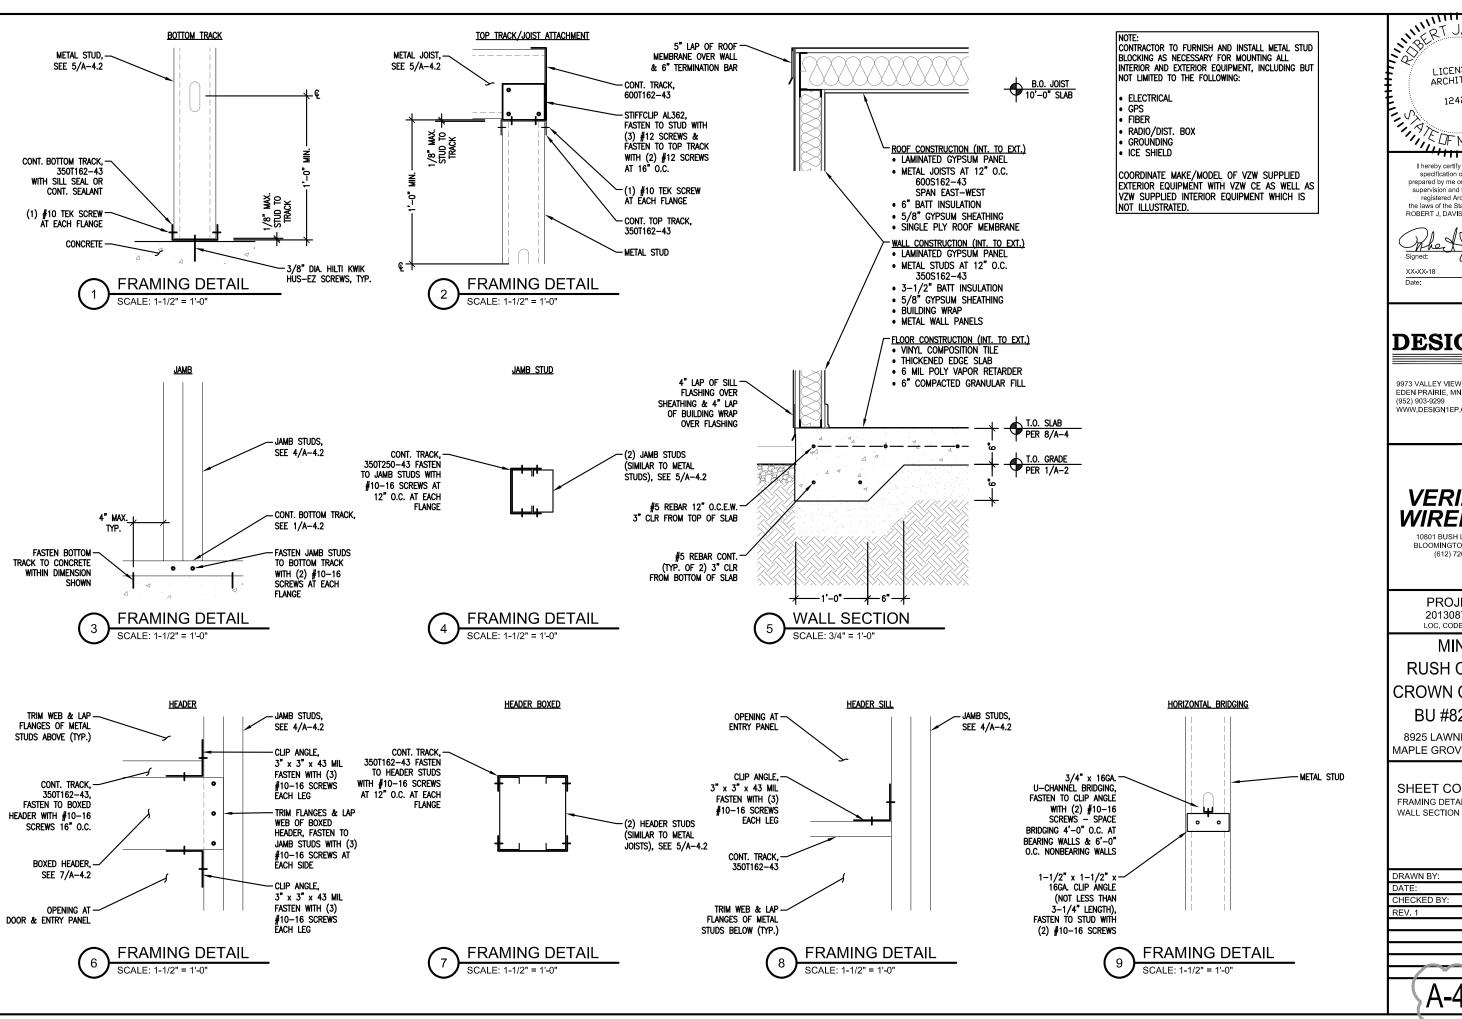

LICENSED ARCHITECT 12427 That this plan

specification or report was prepared by me or under my direct supervision and that I am a duly registered Architect under the laws of the State of Minnesota ROBERT J. DAVIS, Reg. No. 12427

XX-XX-18



9973 VALLEY VIEW RD. EDEN PRAIRIE, MN 55344 (952) 903-9299 WWW.DESIGN1EP.COM

**VERIZON WIRELESS** 

10801 BUSH LAKE ROAD BLOOMINGTON, MN 55438 (612) 720-0052


**PROJECT** 20130877266 LOC. CODE: 265758

MINC **RUSH CREEK CROWN CASTLE** BU #825666

8925 LAWNDALE AVE MAPLE GROVE, MN 5531

SHEET CONTENTS: FRAMING DETAILS

DRAWN BY: MJS DATE 06-06-18 CHECKED BY: BM5 XX-XX-18

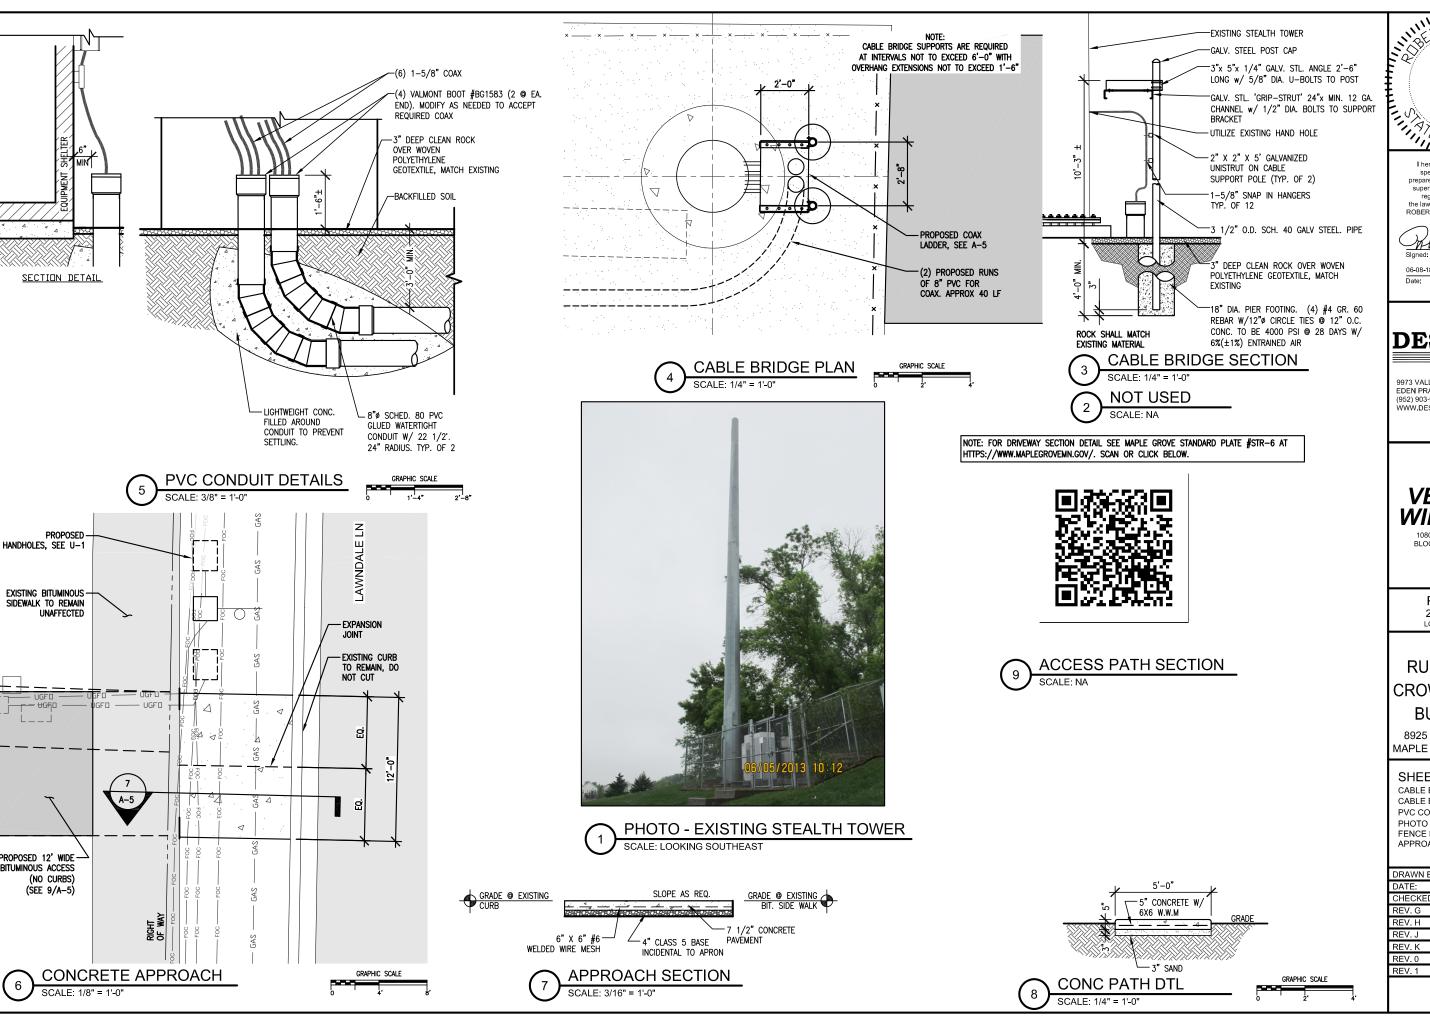

LICENSED ARCHITECT 12427

specification or report was prepared by me or under my direct supervision and that I am a duly registered Architect under the laws of the State of Minnesota. ROBERT J. DAVIS, Reg. No. 12427



EDEN PRAIRIE, MN 55344 (952) 903-9299 WWW.DESIGN1EP.COM

# **VERIZON WIRELESS**

10801 BUSH LAKE ROAD (612) 720-0052

**PROJECT** 20130877266 LOC. CODE: 265758

MINC **RUSH CREEK CROWN CASTLE** BU #825666

8925 LAWNDALE AVE MAPLE GROVE, MN 55311

#### SHEET CONTENTS:

CABLE BRIDGE PLAN CABLE BRIDGE SECTION PVC CONDUIT DETAIL FENCE DETAIL APPROACH DETAIL

DRAWN BY:	TRD
DATE:	08-02-13
CHECKED BY:	CDB
REV. G	03-14-17
REV. H	05-01-17
REV. J	08-02-17
REV. K	10-18-17
REV. 0	02-07-18
REV. 1	06-08-18

A-5

#### GENERAL CONDITIONS

#### 00 0001 PERMITS

Construction Permit shall be acquired by, or in the name of, Verizon Wireless, to be hereinafter referred to as the OWNER. Other permits shall be acquired by the Contractor.

#### 00 0002 SURVEY FFFS

Survey shall be furnished by the Architect. Layout Staking shall be coordinated with the Surveyor per "Request For Quote", (RFQ).

#### 01 0010 INSURANCE & BONDS

Contractor is to furnish Insurance certificates for themselves and subcontractors. Contractor will provide any required Bonding. Contractor agrees to warranty the project for (1) one year after completion.

#### 01 0400 SUPERVISION & COORDINATION

Contractor shall provide supervision throughout the Project, coordinating the work of the Subcontractors, and delivery & installation of Owner-furnished items. Contractor's responsibilities include arranging & conducting of Underground Utilities Locates. Contractor shall comply with municipal, county, state and/or federal codes, including OSHA.

#### 01 0600 TESTIN

Contractor is responsible for providing Agencies with sufficient notice to arrange for Test Samples (i.e.: Concrete Cylinders), and for Special Inspections.

#### 01 2000 MEETINGS

Contractor shall make themselves aware of, and attend, meetings with the Owner and/or Architect. Contractor is to attend a Pre-Construction Meeting of all parties involved, prior to the start of construction.

#### 01 5100 TEMPORARY UTILITIES

Contractor shall maintain the job site in a clean and orderly fashion, providing temporary sanitary facilities, waste disposal, and security (fence area or trailer module).

#### 01 5300 EQUIPMENT RENTAL

Contractor shall furnish equipment necessary to expedite work.

#### 01 5900 FIELD OFFICES & SHEDS

Contractor shall provide security (fence area or trailer module) for tools and materials that remain overnight on site.

#### 01 7000 CLEAN UP & CLOSE OUT

Contractor shall clean up the Site to the satisfaction of Owner. Contractor shall complete the items listed on the Owner's Punch List, and shall sign and return the List to the Owner. Contractor shall maintain a set of drawings during the job, on which changes shall be noted in red ink. A full set of redlined drawings (As-Builts) are to be given to the Architect at Job completion and submit "construction work complete memo" to Construction Engineer.

#### 01 8000 TRUCKS & MILEAGE

Contractor shall provide transportation for their own personnel.

#### 01 8300 TRAVEL TIME & PER DIEM

Contractor shall provide room and board for their own personnel, and reasonable time for traveling to & from job site.

#### 01 9200 TAXES

Contractor shall pay sales and/or use tax on materials and taxable services.

#### <u>SITEWORK</u>

#### 02 1000 SITE PREPARATION & DEMOLITION

Contractor is to mobilize within 7 calendar days of the Owner issuing a 'START' document. Contractor will immediately report to Architect if any environmental considerations arise. Site area defined by timber edging shall be scraped to a depth of 3" minimum to remove vegetative matter. Excess material to be disposed off site in accordance with RFQ.

#### 02 1100 ROAD IMPROVEMENT & CONSTRUCTION

Contractor shall furnish materials for, and install, a twelve foot (12') wide bitumunous roadway from the road access to the work area, for truck and crane access to site.

#### 02 5000 PAVING & SURFACING

New paving shall be according to plans. Asphalt paving shall be per 9/A-5. Concrete paving shall be 5" thick, reinforced with 6"x6" welded wire mesh or #3 steel bars 18" o.c.e.w., over a 3" sand cushion.

#### 02 7800 POWER TO SITE

Contractor shall coordinate the electrical service to the building with the Utility Provider. Conduits shall include pull strings. Underground conduits shall be 2-1/2" Schedule 40 PVC. (schedule 80 PVC under roads and drives) Cable to be 3/0 THWN CU. Trenches shall be backfilled in a timely fashion, using a compactor, and including two (2) detectable ribbons; one each at 3" and 15" above conduit. Service shall be 200 amp, single phase, 120/240 volt. Service type shall be "General Time-Of-Day" if available, and meter base shall be approved by utility provider.

#### 02 7900 TELCO TO SITE

Contractor shall provide 2" SDR-11 HDPE conduit for fiber conduit as noted on Drawings when directional boring is utilized. Contractor shall provide 2" schedule 40 PVC conduit and 2" schedule 80 PVC conduit under roadways with large-sweep elbows for fiber conduit as noted on Drawings when hand trenched. Trenches shall bas in 02 7800

Contractor to provide and install handholes as noted in the Drawings. Additional handholes shall be provided and installed a maximum of 500 feet on center; at 90° bends if directional boring; and every third bend if hand trenched. Handholes size per Drawings and traffic—rated in roadways.

Contractor to provide and install Carlon expansion joint connections at shelter/platform location per manufacturer's specifications and recommendations.

#### 02 8000 SITE IMPROVEMENTS

Areas bounded by fence and adjacent to shelter shall receive polyethylene geotextile, 200 mesh woven, topped with 3" deep 3/4" to 1 1/2" clean rock (no fines). raked smooth, to match existing.

#### 02 8001 FENCIN

Fence shall match existing fence. All fence materials and fittings shall be galvanized steel. Fence shall be 7'-0" high x 9 ga. X 2" chain link fabric. Corner and Gate posts shall be 2 7/8" O.D. sch 40 steel pipe, driven 60" below grade. Line posts shall be 2 3/8" O.D. sch 40 steel pipe. Top Rails shall be 1 5/8" O.D. steel pipe. Gate frames shall be 1 5/8" O.D. welded pipe. Bracing shall be 3/8" truss rods and 1 5/8" O.D. pipe mid-rails at corners. Existing fences shall be protected against damage during this work, and any damage that may occur shall be repaired or replaced to equal existing pre-construction condition. Proposed gate & east side fence modification shall be by original fence installer: Town & Country Fence: 8511 Xylon Ave, Brooklyn Park, MN 55445. Contact: Mark Wassink. Phone: (763)425-5050. Email: info@tcfence.com

#### 02 8500 IRRIGATION SYSTEMS

Contractor shall provide temporary irrigation of new trees, shrubs, and grass, to be maintained so it survives 1 year after plantina.

#### 02 9000 LANDSCAPING

Contractor to restore turf areas damaged by construction by preparing soil, seeding with mulch or hydro—seed & watering to maintain grass survival for 1 year. Contractor shall protect existing landscape elements that are not in the Scope of Work. Reasonable precautions shall be taken to assure the health of existing trees and shrubbery. If conflicts arise regarding the location of root systems, branch lines, etc., the Architect must be contacted prior to performing Work that may cause damage. Damage resulting from disregard of this Article shall be compensated by the Responsible Party and at a cost to be determined by the Property Owner, Architect, and Owner. Contractor shall furnish and install new trees, shrubs, and sod.

#### CONCRETE

#### 03 1000 CONCRETE FORMWORK

Concrete forms shall be dimension lumber, modular, or steel.

#### 03 9000 SHELTER FOUNDATION

Contractor shall furnish & install materials for Shelter foundation. Concrete shall be 6%  $\pm 1\%$  air entrained, and 4,000 psi at 28 days. All reinforcing steel is to be Grade 60 (ASTM 615). Anchor bolts are furnished by Contractor. Contractor shall comply with the Owner's Standard CONSTRUCTION SPECIFICATIONS MINIMUM CONCRETE STANDARDS.

#### METALS

#### 05 0000 METALS

Contractor will furnish and install structural and fabricated steel items not specifically furnished by Owner, and install Owner-furnished items. Structural steel shall be fabricated and erected per AISC specifications. Welding shall conform to AWS standards. Field welding shall be as shown on Shop Drawings, performed by AWS Certified Welders, and inspected as prescribed by the Structural Engineer. Steel shall be ASTM A992 OR A36, and 3/4" field bolts shall be A325. Temporary erecting bolts, clip hangers, and bracing shall be furnished by Contractor. Fabrications shall be shop welded if possible, and galvanized before delivery to site. Structural steel, and miscellaneous iron and steel, shall be hot dipped galvanized per ASTM A123 thickness grade 55. Fabricated iron and steel hardware shall be hot dipped galvanized per ASTM A153. Repair of damaged or uncoated galvanized surfaces shall be per ASTM A780.

#### 05 2000 METAL WALL PANELS

Contractor shall furnish and install metal panels as indicated on the Architectural Documents. Shelter Assembly metal panels shall be stucco embossed steel with vertical lap joints. Color shall be Berridge Manufacturing Company "Almond" or equal.

#### 05 4000 COLD-FORMED METAL FRAMING

Contractor shall furnish and install cold-formed metal framing as described on the Architectural Documents. Stud and joist properties must conform to the latest SSMA and AISI specifications. Studs and joists shall have a G-60 galvanized finish conforming to ASTM C955-06. Steel used in the fabrication of Studs and joists must meet the requirements of ASTM C-653 and fabrication must be in accordance with ASTM C-955. Joists, headers and sill plates shall be constructed of unpunched material and installed continuous without splices. Framing (43MIL-18GA) must have a yield strength of at least 33 KSI. Track members must have a yield strength of at least 33 KSI.

#### WOOD & PLASTICS

#### 06 1600 SHEATHING

Contractor shall furnish and install Fiberglass—Mat Faced Gypsum Sheathing as indicated on the Architectural Documents. Sheathing shall be Type "X" and moisture/mold—resistant such as DensGlass Fireguard Sheathing by Georgia—Pacific Gypsum LLC or equal. Installation per Manufacturer's recommendation and warranty requirements. Fasten Gypsum Sheathing to studs/joists at 8" o.c. (on edges) & 12" o.c. (on field).

#### THERMAL & MOISTURE

#### 07 2000 INSULATION

Contractor shall furnish and install fiberglass batt insulation as indicated on the Architectural Documents. Installation of insulation shall be per Manufacturer's recommendations.

#### 07 2500 BUILDING WRAP (WEATHER BARRIERS)

Contractor shall furnish and install an air & moisture control building wrap as indicated on the Architectural Documents. Building wrap shall be a complete weather barrier system consisting of membrane, seam tape, flashing and fasteners such as DuPont Tyvek CommercialWrap or equal.

#### 07 5000 MEMBRANE ROOFING

Contractor to furnish and install a roof membrane as indicated on the Architectural Documents. Roof membrane shall be a single ply, 60 mil, EPDM and a complete assembly consisting of membrane, mechanical attachment method and 25 year warranty, at a minimum, such as Firestone RubberGard or equal.

Contractor shall protect existing building roof membrane against damage during antenna installation and any damage that may occur shall be repaired or replaced by the contractor.

#### 07 6000 FLASHING AND SHEET METAL

Contractor shall provide materials and labor for details per Architectural Documents. Flashing color shall match the Metal Wall Panels, see specification 05 2000.

#### 07 7920 JOINT SEALER

Contractor shall furnish & install vertical expansion joints in the brick veneer assembly as indicated on the Architectural Documents consisting of an opening through the brick wythe closed with backer rod and sealant to match adjacent mortar joints. Expansion joint sealants shall comply with ASTM C 920, Grade NS, Use M. Consult manufacturer's literature for guidance regarding application.

#### DOORS AND HARDWARE

#### 08 0000 DOORS AND HARDWARE

Contractor shall furnish and install the Factory-Primed Hollow Metal Door Assembly. Assembly shall be  $2'-6'' \times 7'-0''$  fully welded and insulated hollow metal door (16 ga.) and frame (14 ga.), Ceco or equal. Hardware shall be commercial grade and include high security exterior piano hinge, closer, pulls, thermally-broken threshold, weatherstrip and door bottom drip cap shall be commercial grade furnished and installed by Contractor. Lock shall be full mortise type with Best 83t-B deadbolt. See also Electrical Drawings for coordination of electrical door locks, alarm and through—door HVAC unit.

#### **FINISHES**

#### 09 2600 LAMINATED GYPSUM PANEL

Contractor shall furnish and install laminated gypsum panel on interior walls/ceiling as indicated on the Architectural Documents. Product shall be FRP (0.30") laminated fire—rated gypsum panels (0.50"), NUDO F3PB500—FR—MR or equal, color: white. Trim with compatible material.

#### 09 5700 FLOOR COVERING

Vinyl composition tile shall be 1/8" ga. (Armstrong #51830 Cottage Tan, or equal) furnished and installed by Contractor. Base shall be 4" high vinyl, with toe, dark brown color.

#### 09 9000 PAINTING

Contractor shall provide materials/labor for painting per Architectural Documents and touchup painting of construction related scrapes & scratches.

Door/Frame Assembly — Prepare and paint with Sherwin Williams Exterior Grade Alkyd Enamel according to manufacturer's recommendation. Finish Coat color shall match metal wall panels, see specification 05 2000.

#### SPECIAL CONSTRUCTION

#### 13 1250 WAVE GUIDE, (Coaxial Cables)

LDF4-50A= 1/2" nominal, 0.63" actual dia.; 5" min. bending radius; 0.15 lbs/ft AVA5-50= 7/8" nominal, 1.102" actual dia.; 10" min. bending radius; 0.30 lbs/ft AVA7-50= 1-5/8" nominal, 1.98" actual dia.; 15" min. bending radius; 0.72 lbs/ft

#### 13 1400 ANTENNA INSTALL

Contractor shall install Owner's antennas and feed lines during erecting. Contractor shall test and certify feed lines per current VZW standards.

13 3423 TRANSPORT, SET & FRECT SHELTER

Specification removed.

#### 13 3613 TRANSPORT AND INSTALL ANTENNAS

Contractor shall schedule delivery of Owner—furnished Materials, and provide means for unloading and erecting. Contractor shall provide crane(s) and/or truck for setting shelter & platform per RFQ. Contractor to furnish and install antennas.

#### **MECHANICAL**

15 5000 HVAC

Contractor shall furnish and install one through—door HVAC unit as per Electrical Drawings.

#### ELECTRICAL

16 5000 LIGHTING AND FLECTRICAL

Contractor shall perform work as described on the Electrical Plans. Contractor shall provide labor and materials as necessary to complete the work shown on plans. If service is sub-metered from an existing service, sub-meter shall be 10x or 16x type.

#### 16 6000 GROUNDING

Contractor shall make themselves familiar with and follow the current GROUNDING STANDARDS of VERIZON WIRELESS. Contractor shall perform work as shown on Grounding Plans. Any site—specific grounding issues not covered by the GROUNDING STANDARD are to be addressed by the Contractor to the Owner.

#### OWNER-FURNISHED EQUIPMENT & FEES

INTEGRATED LOAD CENTER
CAM-LOC
HYBRID CABLES
ANTENNAS AND DOWNTILT BRACKETS
GPS
BUILDING PERMIT FEE
MATERIALS TESTING FEES
SPECIAL INSPECTIONS FEES

CONTRACTOR—FURNISHED EQUIPMENT
POWER TO SITE
TELCO TO SITE
CONNECTORS, BOOTS, RELATED HARDWARE
GPS MOUNTING
GROUNDING MATERIALS
PVC MATERIALS
FENCE MATERIALS
RETAINING WALL
TREE

#### SCOPE OF WORK:

SHELTER MATERIALS & HVAC

CONTRACTOR SHALL PROVIDE MATERIALS, LABOR, TOOLS, TRANSPORTATION, SUPERVISION, ETC. TO FULLY EXECUTE WORK. WORK REQUIREMENTS ARE DETAILED ON THE DRAWINGS AND SPECIFICATIONS AND SHALL INCLUDE, BUT NOT BE LIMITED TO, THE FOLLOWING ITEMS:


ELECTRICAL/TELEPHONE SERVICE
ROUTING OF GROUND, POWER, FIBER AND ALARM

#### SHELTER CONSTRUCTION

INSTALL ANTENNAS & CABLES

INSTALL GATE & MODIFY FENCE
REMOVE & INSTALL RETAINING WALL/TREE
REMOVE & INSTALL TREE
SITE PREPARATION/WORK/GROUNDING
BITUMINOUS ACCESS ROAD
CONCRETE APPROACH APRON/SIDEWALK
PVC INSTALLATION

Contractor to compare drawings against Owner's "Request for Quote", (RFQ). If discrepancies arise, Contractor shall verify with Owner that the RFQ supersedes the drawings.

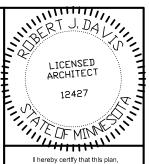

I hereby certify that this plan, specification or report was prepared by me or under my direct supervision and that I am a duly registered Architect under the laws of the State of Minnesota. ROBERT J. DAVIS, Reg. No. 12427







9973 VALLEY VIEW RD. EDEN PRAIRIE, MN 55344 (952) 903-9299 WWW.DESIGN1EP.COM

# VERIZON WIRELESS

10801 BUSH LAKE ROAD BLOOMINGTON, MN 55438 (612) 720-0052

> PROJECT 20130877266 LOC. CODE: 265758

# MINC RUSH CREEK CROWN CASTLE BU #825666

8925 LAWNDALE AVE MAPLE GROVE, MN 5531

SHEET CONTENTS:

DRAWN BY:	TRD
DATE:	08-02-13
CHECKED BY:	CDB
REV. G	03-14-17
REV. H	05-01-17
REV. J	08-02-17
REV. K	10-18-17
REV. 0	02-07-18
REV. 1	06-08-18

A-6

#### **GENERAL GROUNDING NOTES:**

An external buried ground ring (Lead 1) shall be established around the equipment shelter and tower foundations. Lead 1 shall be kept 24" from foundations; if foundations are less than 48" apart, keep Lead 1 centered between them. If the tower base is over 20'-0" from the equipment shelter, a separate Lead 1 shall be established around each foundation and the two Lead 1s shall be bonded with two parallel leads at least 6 feet apart horizontally. Connections between the two Lead 1s shall be bi-directional.

All subgrade connections shall be by exothermic weld, brazed weld, or gas-tight UL467-listed compression fittings pre-filled with anti-oxidant compound. Subgrade connections shall <u>not</u> be 'cold galvanize' coated.

Lead 1 shall be #2 solid bare tin-clad (SBTC) copper wire buried at local frost depth. Lead 1 bends shall be minimum 24" radius. 'Whip' lead bends may be of 12" radius.

Ground rods shall be galvanized steel, 5/8"Ø, spaced twenty feet apart or as shown. Rods shall be kept min. 24 inches from foundations. Ground rods are required to be installed at their full specified length Depth shall be as shown in Detail 1/G1.

SPECIAL CONSIDERATIONS FOR GROUND RODS

When ground rods are not specified to be backfilled w/ Bentonite Slurry: If boulders, bedrock, or other obstructions prevent driving of ground rods, the Contractor will need to have drilling equipment bore a hole for ground rod placement. Hole to be backfilled w/ Bentonite Slurry

When specified with slurried Bentonite encasement, drilling equipment will be need to be used to be bore a hole for ground rod placement. Slurry shall be made from pelletized material ("Grounding Gravel"); powdered Bentonite is not allowed. If boulders, bedrock, or other obstructions are found, Contractor shall drill to the specified depth and provide Bentonite encasements.

Above-grade connections shall be by lugs  $\mathbf{w}/$   $\mathbf{two-hole}$ tongues unless noted otherwise, joined to solid leads by welding (*T&B 54856BE "BROWN"*), self-threading (RECOGNIZED, EM 2522DH.75.312), or 10,000psi crimping (BURNDY YA3C 2TC 14E2). Surfaces that are galvanized or coated shall have coating(s) removed prior to bolting. Bolts shall be stainless steel with flat washers on each side of the connection and a lock washer beneath the fastening nut. Star-tooth washers shall be used between lua & dissimilar metal (copper-to-steel, etc) but are not required between tin-clad CU lugs & tin-clad CU bus bars. Lug tongues shall be coated with anti-oxidant compound, and excess compound wiped clean after bolting. The connection shall then be coated with cold-aglyanizing compound, or with color-matching paint.

Ground hars exposed to weather shall be tin-clad copper, and shall be clean of any oxidation prior to lug

Galvanized items shall have zinc removed within 1" of weld area, and below lug surface contact area. After welding or bolting, the joint shall be coated with cold galvanizing compound.

#### <u>Ground Bar leads</u>

Ground bars are isolated electrically from tower bottoms and equipment shelters by their standoff mounts. Leads from each ground bar to the ground ring shall be a pair of #2 SBTC, each connected to Lead 1 bi-directionally with #2 SBTC 'jumpers'. Pairs of #2 SBTC may be required between ground bars. Leads shall be routed to around bars as follows:

- \* The Main Ground Bar (MGB), typically mounted inside on the equipment shelter 'back' wall.
- \* The Entry Cable Port Ground Bars (ECPGB), mounted inside and outside on the equipment shelter walls beneath the transmission line port. Note: Transmission line grounds also attach to the ECPGBs.
- \* The Transmission Line Ground Bar (TGB) mounted at the base of the tower to which the transmission line grounds are attached. Transmission line grounds also attach to the TGBs.

NOTE: Contractor shall confirm that TGBs exist at 75-foot vertical intervals on any guyed or self-support tower, and that transmission lines are arounded to each TGB. Only the bottom—most TGB is isolated from the tower steel frame; upper TGBs may use the tower steel frame as common ground, requiring no copper leads between TGBs.

#### #2 SBTC Whip leads

"Whip" leads shall connect the buried external ground ring to the following items:

\* Three whips to flanges on the monopole base, at least 90° apart. If none are provided, attach to the baseplate or consult tower manufacturer.

#### Self-Support Towers:

\* Two whips to flange(s) on each tower leg base. If none are provided, attach to the baseplate or consult tower manufacturer.

#### Guved Towers:

- \* Two whips to flange(s) on the tower base. If none are provided, attach to the baseplate or consult tower manufacturer.
- \* Establish a Lead 1 within the fence enclosure of each guy anchor, at least 40 foot perimeter and having 4 ground rods.
- \* #2 SBTC leads shall extend up, and be clamped (bronze clamshell or equal), to any two guy wires. NEVER weld leads to the guy wires. The lead to the guy anchor 'hand' plate may be welded.

Metallic fence within 25 feet of tower Lead 1, or within 6 feet of shelter lead 1, shall have whip leads as follows:

- Fach corner post
- \* Each pair of gate posts.
- \* Any line post over 20'-0" from a grounded post.
- \* Each gate leaf to its respective gatepost using braided strap (3/4", tin-clad copper w/ lug ends).
- Fences around guy anchors shall be grounded in

NEVER WELD to any fuel enclosure. NEVER penetrate the fuel containment. Metal tanks shall have one whip lead attached. Use an approved clamp or two-hole lug on an available flange.

Equipment Shelter and Other General Requirements: Extend new Lead 21B up to shelter halo, remaking two-way connections as needed. Generator-equipped shelters have 6 such connections. Connections within the shelter shall be by compression; NEVER weld inside

- \* Each vertical support pipe of the exterior cable bridge. Bridge end shall be kept at least 6" from the tower structure. The cable bridge shall be jumpered to the vertical support pipes with #2 SBTC at each vertical
- Opposite corners of the roof shield over the equipment shelter
- \* Each HVAC unit shield, if separate (may be 'jumpered' to main roof shield).
- Each HVAC package unit.
- Commercial electric meter box
- Generator receptacle, if present.
- Steel building skid, if shelter is metal frame.
- \* Each air intake or exhaust fan vent louver.
- \* Each generator vent hood or louver.
- \* Generator exhaust stack, external.
- \* Opposite corners of generator support frame, if separate from shelter.
- Generator fuel tank, if separate from generator unit. Host building rain gutter, downspouts, and roof flashings within 25 feet.
- \* Telco MPOP (Main Point of Presence), if external to equipment shelter.
- \* Within cable vaults, one each to the ladder and to the manhale rim.

Note: The door frame is connected to the interior ground halo, and need no separate connection to the external ground ring.

#### Inspection & Testing

Test lead #1 and ground rods after installation but before backfilling or connecting to any other grounding, using the 3-point fall of potential method. Contractor to notify Verizon Wireless senior construction engineer at least 48 hours prior to testing. Document installation and test results with photographs.

#### SYMBOL AND NOTE LEGEND

---(1)--- #2 SBTC AROUND SHELTER, TOWER, OR GUY ANCHOR

5/8" X 10'-0" GALVANIZED STEEL GROUND ROD

TEST WELL PREFERRED LOCATION

#2 SBTC 'WHIP' LEAD

(2) #2 SBTC FROM MGB, PGB, OR TGB TO LEAD 1

6 AC

(21B) BC BUILDING CORNER

6 ВО BOLLARD

6 CBS CABLE BRIDGE SUPPORT POST

4 EL ELECTRICAL SERVICE GROUND

(6) EM COMMERCIAL ELECTRICAL METER

**6**) FAN GUY ANCHOR PLATE **(6)** FP FENCE POST

90) GEN GENERATOR

 $\mathcal{C}$ GP GATE POST, 3/4" BRAID STRAP TO LEAF

6 GPS

6 GUY GUY WIRE, MECH, CLAMP ONLY - NO WELDS

**(6)** HOOD OR LOUVER HI

**(6)** HR OUTSIDE OF HOFFMAN BOX

6 ILC INTEGRATED LOAD CENTER

(5) MGB MAIN GROUND BAR

**6**) GENERATOR MUFFLER MU

(5) PGB PORT GROUND BAR

6 RBR FOUNDATION REINFORCING

6 RS ROOF SHIELD

6 SB STEEL BEAM

6 SP STEEL POST

6 STP STEEL PLATFORM

6 TEL HOFFMAN BOX


(5) TGB TOWER GROUND BAR


6 TWR TOWER BASE


6 VP DIESEL FUEL VENT PIPE

#### <u>Note:</u>

Contractor to provide #2 solid bare tin-clad (SBTC) copper wire lead from #1 ground ring to air conditioner & ice shield if provided by VZW

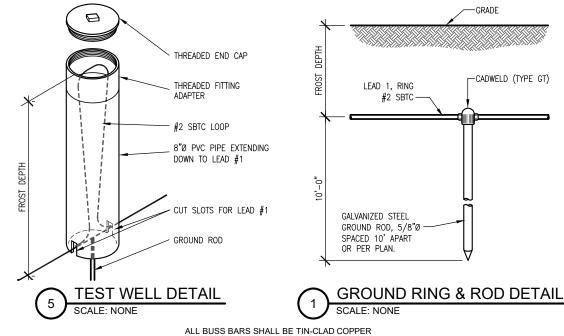

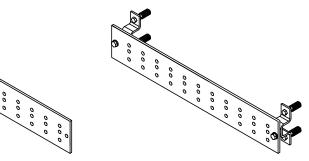

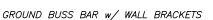


**GROUND BUSS BAR DETAILS** 

GATE STRAPS TO BE CADWELDED TO POSTS


BELDEN

BRAIDED

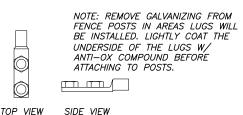

TWO-HOLE 10,000 PSI UL 9498 LISTED

GROUND BUSS BAR

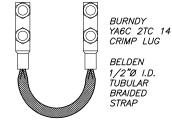

GATE CALDWELDED TO FENCE POST TWO\_HOLE 10,000 PSI COMPRESSION FITTING 3/4" BRAIDED TINNED COPPER JUMPER STRAP HYTAP CONNECTOR 10,000 PSI COMPRESSION FITTING FITTING MUST BE UL467 LISTED ACCEPTABLE FOR DIRECT BURIAL

WELD: THOMAS & BETTS. 54856BE "BROWN33"


CRIMP: BURNDY, YA3C 2TC 14E2, 10,000 PSI

SCREW: RECOGNIZED, EM 2522DH.75.312

GROUND BUSS BAR


w/ ANGLE ADAPTERS

# **COMPRESSION CONNECTOR DETAILS**

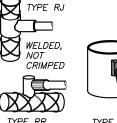

REINF. BAR

TYPE VS ROUND SURFACE

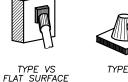










TYPE PT TYPE GL LUG

**EXOTHERMIC WELD DETAILS** SCALE: NONE

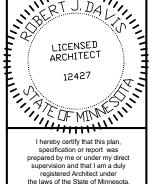

ROBERT J. DAVIS, Reg. No. 12427 02-07-18



9973 VALLEY VIEW RD. EDEN PRAIRIE MN 55344 (952) 903-9299 WWW.DESIGN1EP.COM

# **VERIZON WIRELESS**

10801 BUSH LAKE ROAD BLOOMINGTON, MN 55438 (612) 720-0052

**PROJECT** 20130877266 LOC. CODE: 265758

# MINC **RUSH CREEK CROWN CASTLE** BU #825666


8925 LAWNDALE AVE MAPLE GROVE, MN 5531


## SHEET CONTENTS:

GENERAL NOTES GROUND RING & ROD DETAIL BUSS BAR DETAILS CONNECTOR DETAILS **EXOTHERMIC WELD DETAILS** TEST WELL DETAIL

DRAWN BY:	TRD
DATE:	08-02-13
CHECKED BY:	CDB
REV. F	08-19-16
REV. G	03-14-17
REV. H	05-01-17
REV. J	08-02-17
REV. K	10-18-17
REV. 0	02-07-18

G-′

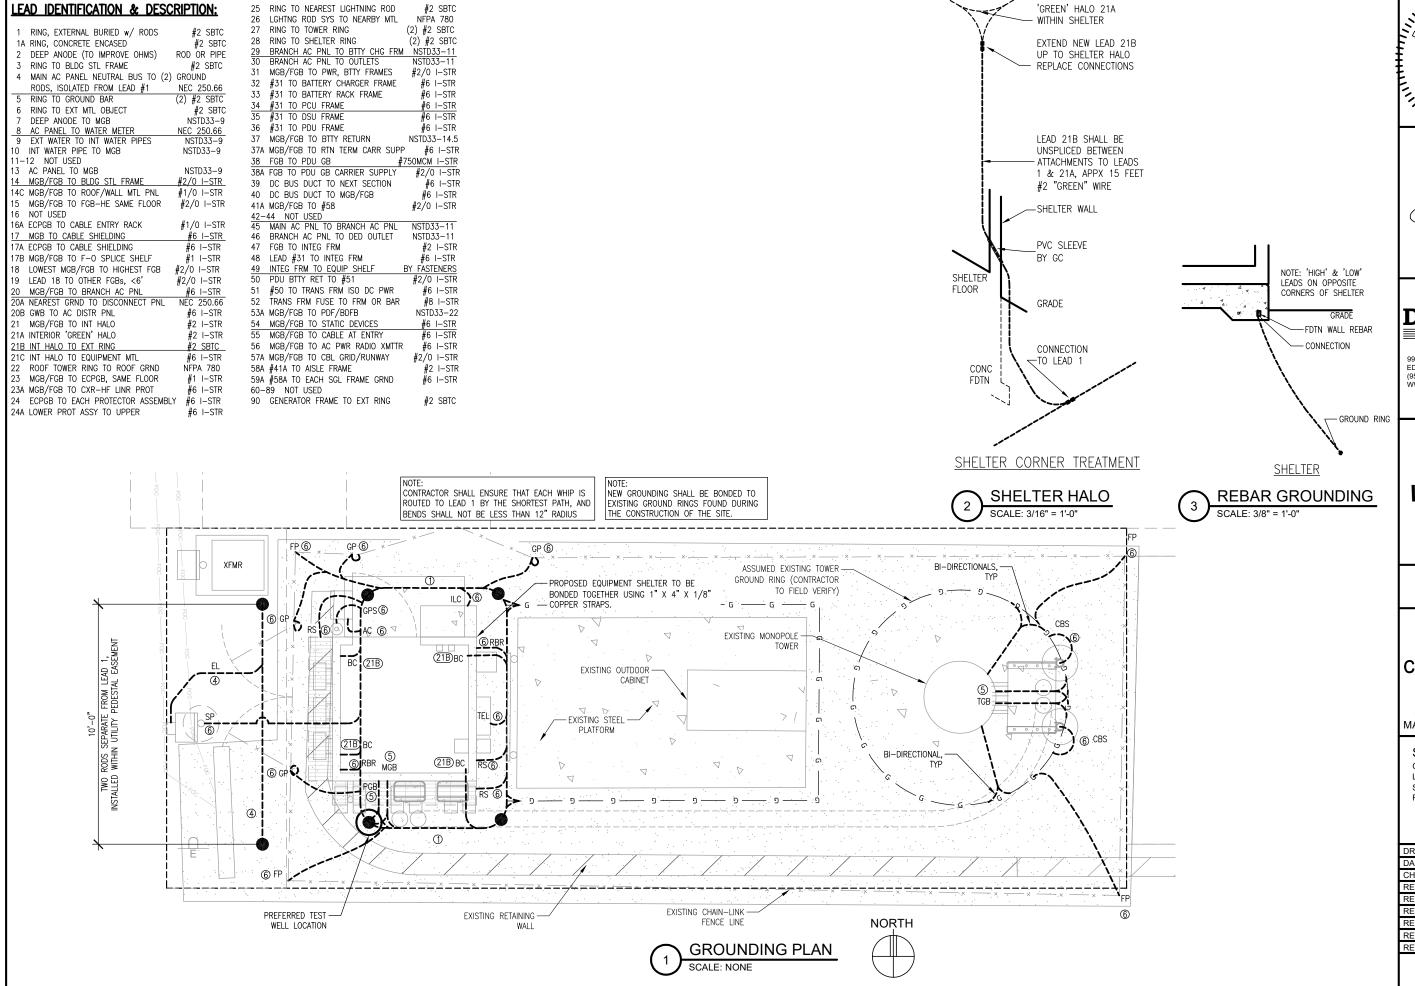

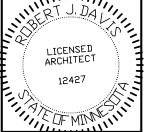

I hereby certify that this plan, specification or report was prepared by me or under my direct supervision and that I am a duly registered Architect under the laws of the State of Minnesota. ROBERT J. DAVIS, Reg. No. 12427

The Jule (Signed:

DESIGN

9973 VALLEY VIEW RD. EDEN PRAIRIE, MN 55344 (952) 903-9299 WWW.DESIGN1EP.COM

# VERIZON WIRELESS

10801 BUSH LAKE ROAD BLOOMINGTON, MN 55438 (612) 720-0052

PROJECT 20130877266 LOC. CODE: 265758

# MINC RUSH CREEK CROWN CASTLE BU #825666


8925 LAWNDALE AVE MAPLE GROVE, MN 5531

#### SHEET CONTENTS

GROUNDING PLAN LEAD IDENTIFICATION SHELTER CORNER DETAIL FOUNDATION LEADS

REV. 0	02-07-18
REV. K	10-18-17
REV. J	08-02-17
REV. H	05-01-17
REV. G	03-14-17
REV. F	08-19-16
CHECKED BY:	CDB
DATE:	08-02-13
DRAWN BY:	TRD

**G-2** 

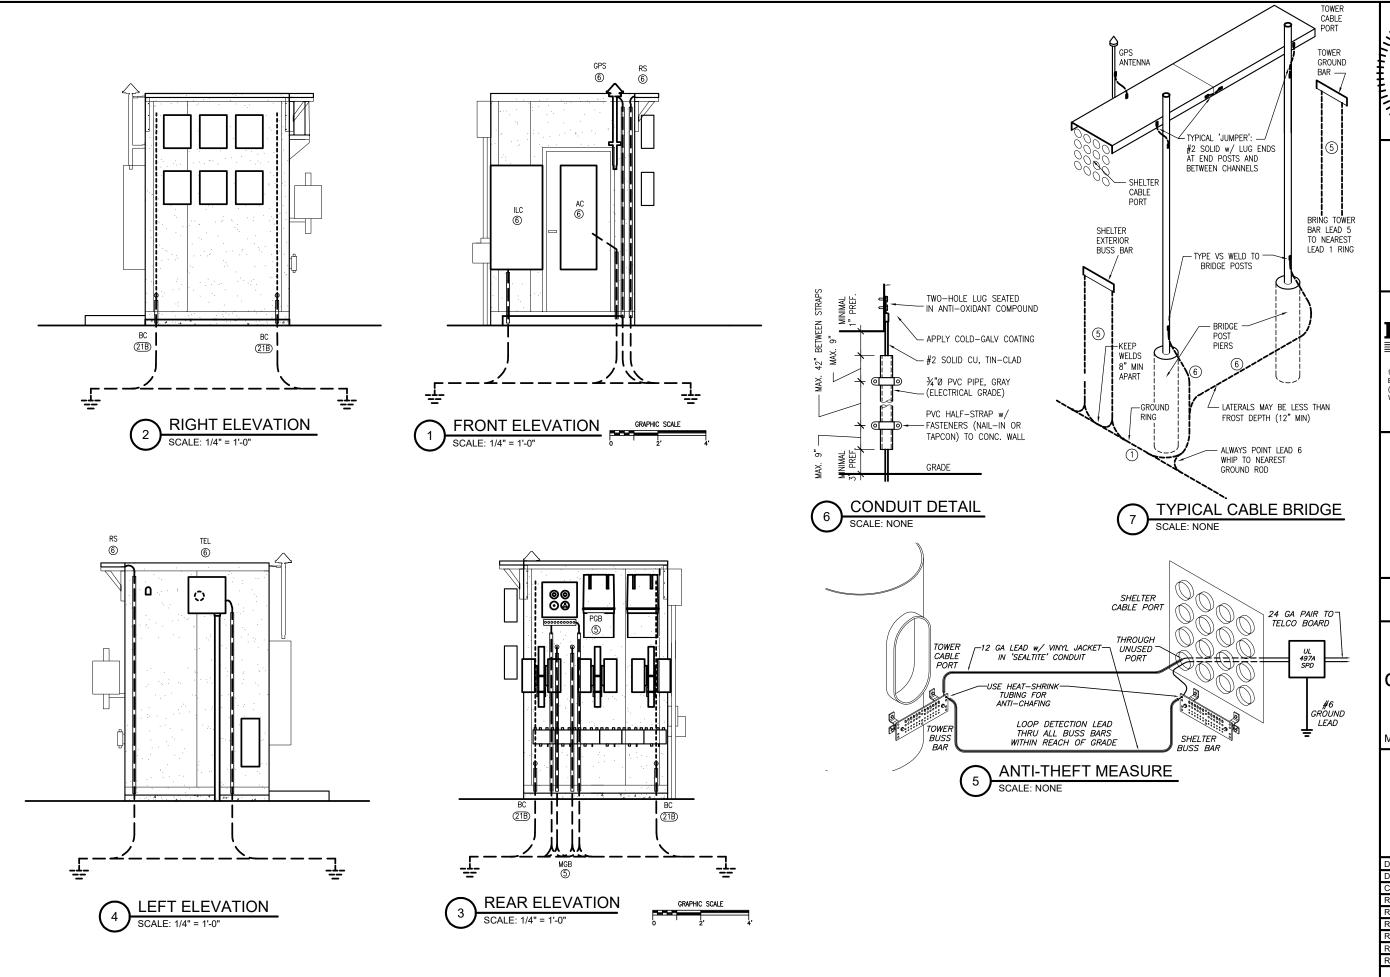

LICENSED ARCHITECT
12427

I hereby certify that this plan, specification or report was prepared by me or under my direct supervision and that I am a duly registered Architect under the laws of the State of Minnesota. ROBERT J. DAVIS, Reg. No. 12427

The Jule (

# DESIGN

9973 VALLEY VIEW RD. EDEN PRAIRIE, MN 55344 (952) 903-9299 WWW.DESIGN1EP.COM

# **VERIZON WIRELESS**

10801 BUSH LAKE ROAD BLOOMINGTON, MN 55438 (612) 720-0052

PROJECT 20130877266 LOC. CODE: 265758

# MINC RUSH CREEK CROWN CASTLE BU #825666


8925 LAWNDALE AVE MAPLE GROVE, MN 5531


#### SHEET CONTENTS:


EXTERIOR ELEVATIONS CONDUIT, STOOP, ANTI-THEFT, BRIDGE, TOWER BASE DETAILS

DRAWN BY:	TRD
DATE:	08-02-13
CHECKED BY:	CDB
REV. F	08-19-16
REV. G	03-14-17
REV. H	05-01-17
REV. J	08-02-17
REV. K	10-18-17
REV. 0	02-07-18

G-3

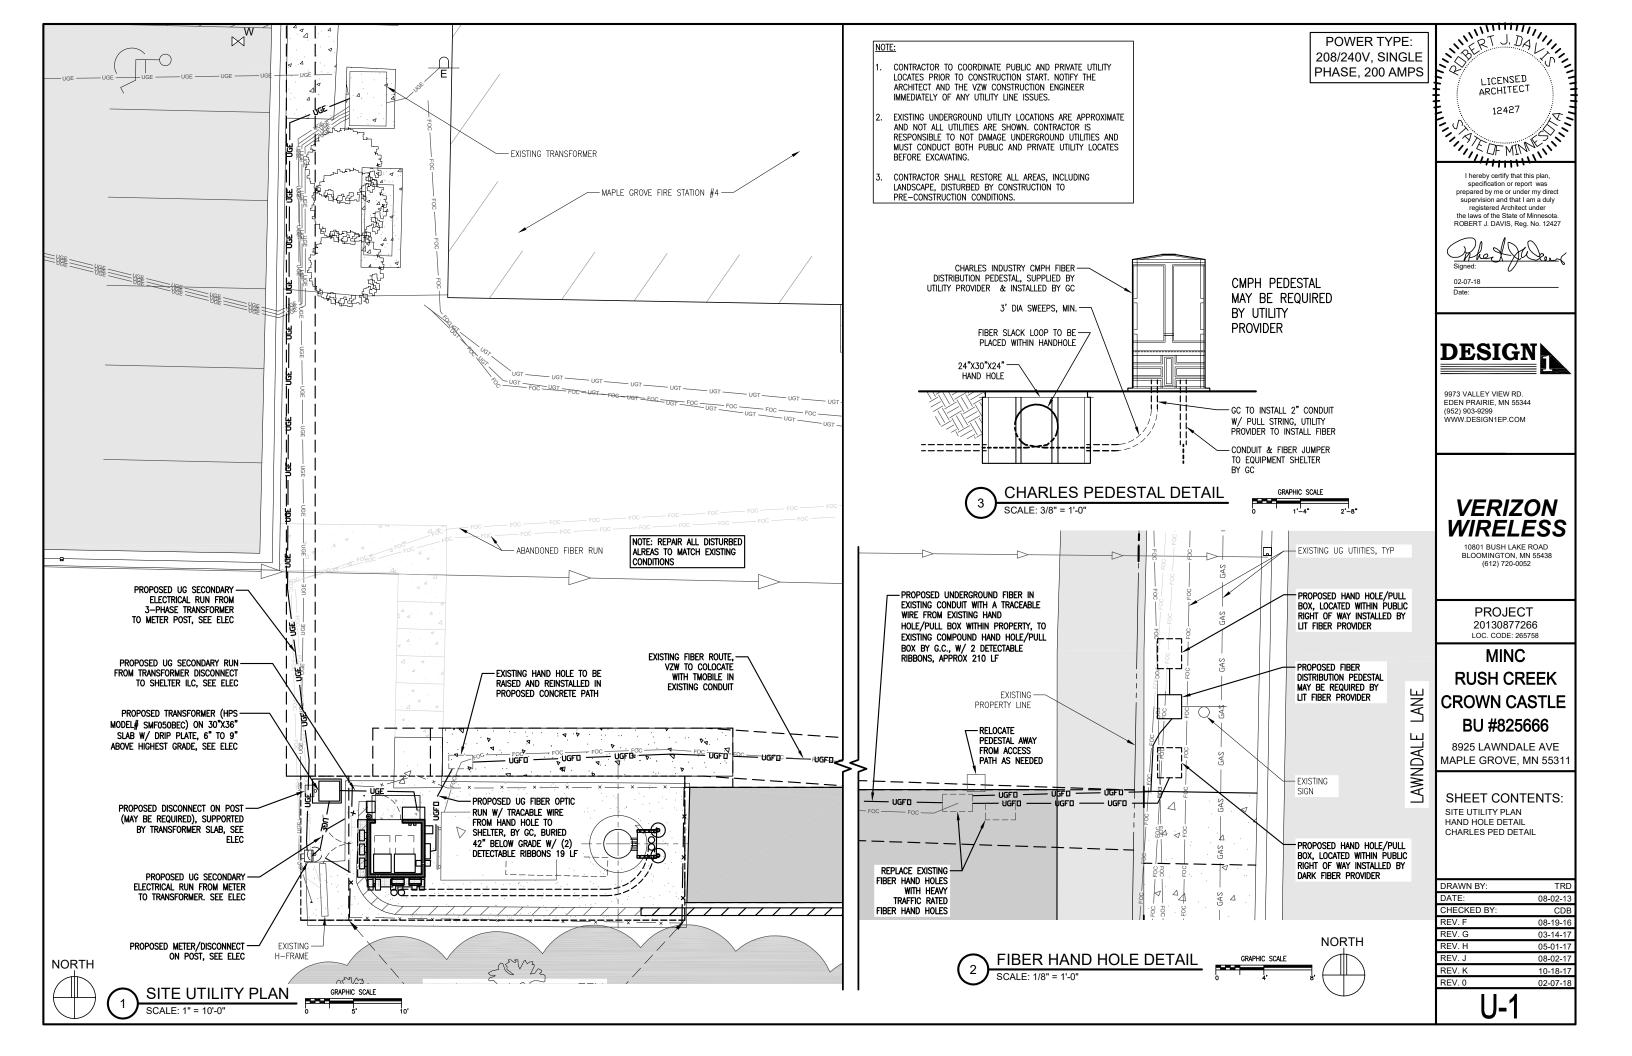

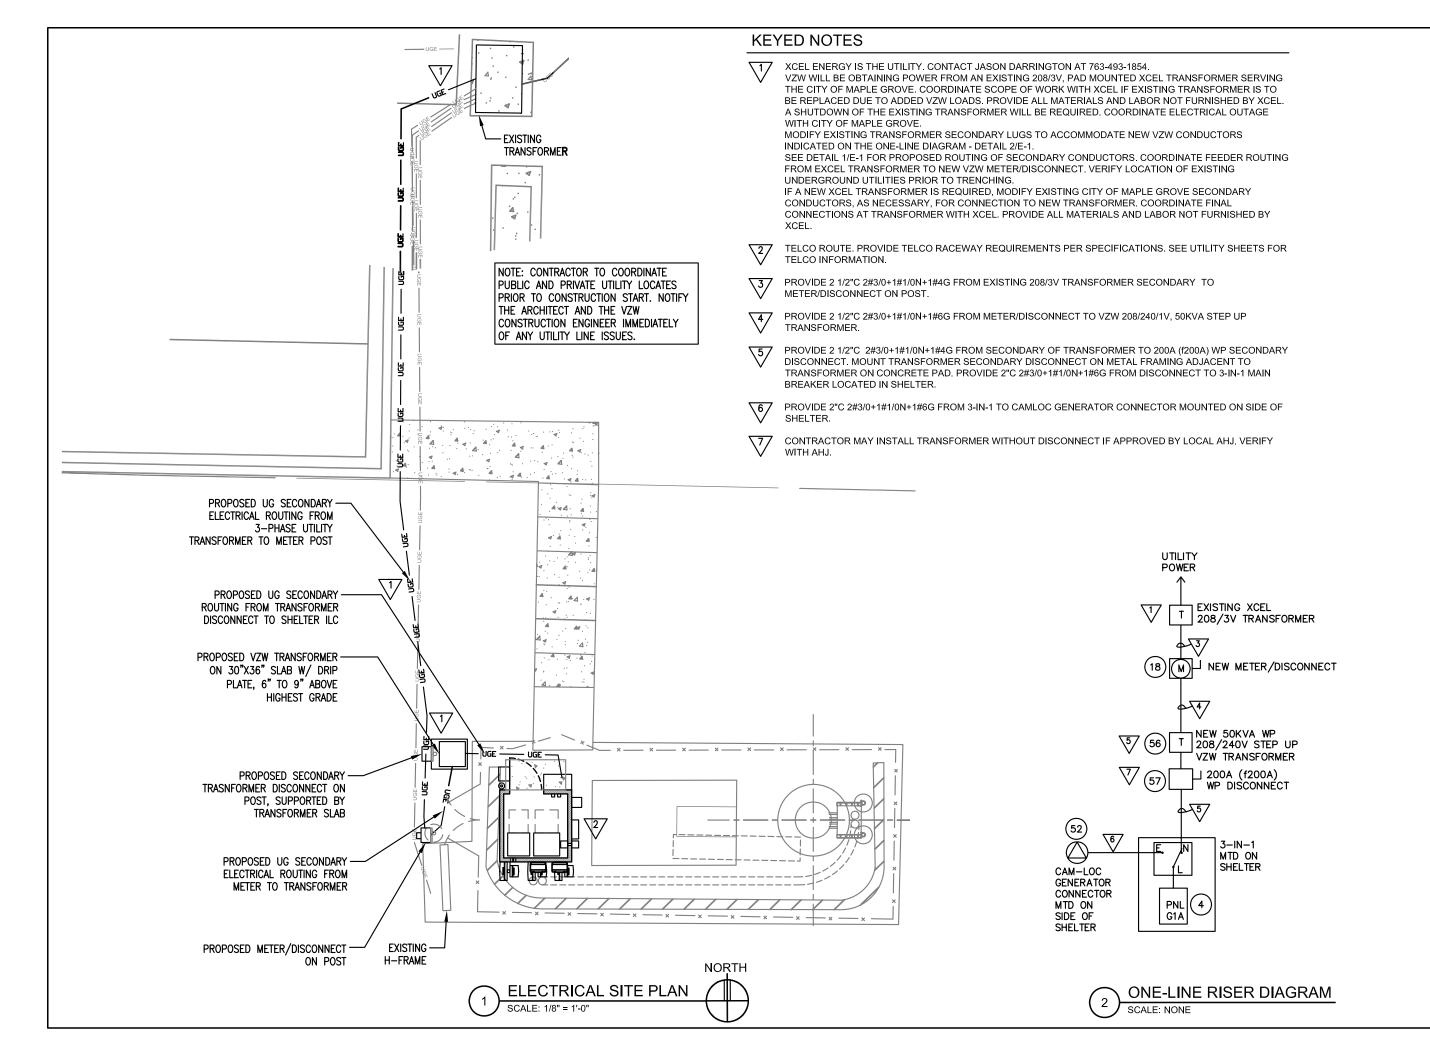

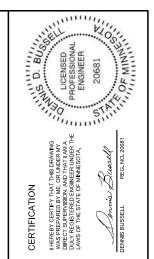



Bussell Companies, Inc. 16026 Minnetonka Blvd., St. 100 Minnetonka, MN 55345-1301 952-931-2111 www.bussellcompanies.com



9973 VALLEY VIEW RD. EDEN PRAIRIE, MN 55344 (952) 903-9299 WWW.DESIGN1EP.COM

# VERIZON WIRELESS

10801 BUSH LAKE ROAD BLOOMINGTON, MN 55438 (612) 720-0052

PROJECT 20130877266 LOC. CODE: 265758

## MINC RUSH CREEK CROWN CASTLE BU #825666

LAWNDALE LANE N MAPLE GROVE, MN 5531

## SHEET CONTENTS:

ELECTRICAL ROOF PLAN AND DETAILS

DRAWN BY:	AB
DATE:	02-19-14
CHECKED BY:	DB
REV. A	09-16-13
REV. A.1	05-08-14
REV. B	06-04-14
REV. C	06-12-15
REV. D	03-21-16
REV. E	04-12-16
REV. G	02-07-17

#### **GENERAL ELECTRICAL NOTES:**

- SUBMITTAL OF BID INDICATES CONTRACTOR IS AWARE OF ALL JOB SITE CONDITIONS AND WORK TO BE PERFORMED UNDER THIS CONTRACT.
- 2. CONTRACTOR SHALL PERFORM ALL VERIFICATION OBSERVATION TESTS, AND EXAMINE WORK PRIOR TO THE ORDERING OF THE ELECTRICAL EQUIPMENT AND THE ACTUAL CONSTRUCTION. CONTRACTOR SHALL ISSUE A WRITTEN NOTICE OF ALL FINDINGS TO THE ARCHITECT LISTING ALL MALFUNCTIONS, FAULTY EQUIPMENT AND DISCREPANCIES.
- 3. HEIGHTS SHALL BE VERIFIED WITH OWNER PRIOR TO INSTALLATION.
- THESE PLANS ARE DIAGRAMATIC ONLY. FOLLOW AS CLOSELY AS POSSIBLE.
- 5. EACH CONDUCTOR OF EVERY SYSTEM SHALL BE PERMANENTLY TAGGED IN EACH PANELBOARD, PULLBOX, J—BOX, SWITCH BOX,
- 6. CONTRACTOR SHALL PROVIDE ALL LABOR,
  MATERIALS, INSURANCE, EQUIPMENT, INSTALLATION,
  CONSTRUCTION TOOLS, TRANSPORTATION, ETC., FOR
  A COMPLETE AND PROPERLY OPERATIVE SYSTEM
  ENERGIZED THROUGHOUT AND AS INDICATED ON
  DRAWINGS.
- 7. ALL MATERIALS AND EQUIPMENT SHALL BE NEW AND IN PERFECT CONDITION WHEN INSTALLED AND SHALL BE OF THE BEST GRADE AND OF THE SAME MANUFACTURER THROUGHOUT FOR EACH CLASS OR GROUP OF EQUIPMENT. MATERIALS SHALL BE LISTED AND APPROVED BY U.L. MATERIALS SHALL BE MANUFACTURED IN ACCORDANCE WITH STANDARDS ESTABLISHED BY ANSI, NEMA AND NBFU.
- 8. CONTRACTOR SHALL CARRY OUT HIS WORK IN ACCORDANCE WITH ALL GOVERNING STATE, COUNTY AND LOCAL CODES.
- 9. CONTRACTOR SHALL SECURE ALL NECESSARY BUILDING PERMITS.
- 10. COMPLETE JOB SHALL BE GUARANTEED FOR A PERIOD OF ONE (1) YEAR AFTER THE DATE OF JOB ACCEPTANCE BY OWNER. ANY WORK, MATERIAL OR EQUIPMENT FOUND TO BE FAULTY DURING THAT PERIOD SHALL BE CORRECTED AT ONCE, UPON WRITTEN NOTIFICATION, AT THE EXPENSE OF THE CONTRACTOR.
- 11. ALL CONDUIT SHALL HAVE A PULL WIRE.

- 12. PROVIDE CONSTRUCTION MANAGER WITH ONE SET OF COMPLETE ELECTRICAL "AS-BUILT" DRAWINGS AT THE COMPLETION OF THE JOB, SHOWING ACTUAL DIMENSIONS, ROUTINGS, AND CIRCUITS.
- 13. ALL BROCHURES, OPERATING MANUALS, CATALOGS, SHOP DRAWINGS, ETC. SHALL BE TURNED OVER TO OWNER AT JOB COMPLETION.
- 14. MULTI-WRE CIRCUITS WITH COMMON NEUTRAL CONDUCTOR SHALL NOT BE ALLOWED.
- 15. ALL CONDUCTORS SHALL BE COPPER. WIRE SMALLER THAN #6 AWG TO BE STRANDED, THHN CONDUCTORS. EXCEPTION: AWG TELCO WIRE AND #12/#14 AWG WIRE USED FOR A.C. CONTROLS TO BE SOLID COPPER.
- 16. ALL ELECTRICAL EQUIPMENT SHALL HAVE AN INTERRUPTING RATING NOT LESS THE MAXIMUM SHORT CIRCUIT CURRENT TO WHICH THEY MAY BE SUBJECTED, AND A MINIMUM OF 10,000 A.I.C.
- 17. THE ELECTRICAL SYSTEM SHALL BE GROUNDED AND BONDED AS REQUIRED BY ALL APPLICABLE CODES. A SEPARATE GREEN GROUNDING CONDUCTOR SHALL BE "PIGTAILED" AT EACH J-BOX, WITH A SEPARATE PIGTAIL TO A GREEN GROUNDING SCREW ATTACHED TO THE "TAPPED" 10-32 HOLE IN THE BOX. ADDITIONALLY, ANOTHER GREEN PIGTAIL IS TO BE FASTENED TO ALL YOKES OF DEVICES, AND TO METAL CASES OF LIGHTING FIXTURES. THE USE OF GROUNDING CLIPS IS NOT ACCEPTABLE.
- 18. RECEPTACLES SHALL BE 20 AMPERE, 125 VOLT A.C., SPECIFICATION GRADE, WHITE.
- WALL SWITCHES SHALL BE SINGLE-POLE, HUBBELL #1201 OR EQUIVALENT, WHITE.
- 20. PLASTIC PLATES FOR ALL SWITCHES, RECEPTACLES, TELEPHONE AND BLANKED OUTLETS, SHALL HAVE ENGRAVED LETTERING. WEATHERPROOF RECEPTACLES SHALL HAVE RACO #800, 1/2" RAISED WORK COVERS.
- 21. CONDUCTORS SHALL BE COPPER #12 AWG MINIMUM, NO BX OR ROMEX CABLE IS PERMITTED.
- 22. NOT USED.

23. METER SOCKET AMPERES, VOLTAGE, NUMBER OF PHASES SHALL BE AS NOTED ON THE DRAWINGS.

MANUFACTURED BY SQUARE D CO. OR APPROVED EQUAL. IF HOST FACILITY REQUIRES THE NEW SERVICE TO BE SUB-METERED FROM THE EXISTING SERVICE, SUB-METER SHALL BE OF THE 10xOR 16x TYPE.

24. ALL MATERIALS SHALL BE U.L. LISTED.

5. CONDUIT:
A. SERVICE CONDUITS SHALL BE GRAY SCH.40 PVC
BURIED MIN. 36", EXCEPT THAT SCH.80 SHALL BE USED
UNDER ROADWAYS AND IN LOCATIONS SUBJECT TO
IMPACTS. BENDS SHALL BE MADE USING "WIDE SWEEP"
(12" MIN. RADIUS) ELBOW FITTINGS. ANY RIGID STEEL
CONDUIT SHALL BE U.L. LABEL, MIN. 36" BELOW GRADE,
WITH "SWEEP" ELBOWS (12"R.MIN.) ENDING IN PVC

TRANSITION FITTINGS. RIGID CONDUIT IN CONTACT WITH EARTH SHALL BE 1/2 LAP—WRAPPED WITH HUNTS PROCESS NO. 3 EXTENDING MIN. 12" ABOVE GRADE.

B. INTERIOR CONDUITS SHALL BE EMT; FITTINGS SHALL BE RING COMPRESSION TYPE.

C. SEALTITE FLEXIBLE METALLIC CONDUIT MAY BE USED

WHERE PERMITTED BY CODE. FITTINGS SHALL BE "JAKE" OR "SQUEEZE" TYPE. SEALTITE CONDUIT SHALL EXCEED SIX FEET IN LENGTH. WHEN EXPOSED TO WEATHER, THEN USE UV RESISTANT FLEXIBLE NONMETALIC LIQUIDTITE CONDUIT.

26. ELECTRICAL EQUIPMENT SHALL BE LABELED WITH PERMANENT ENGRAVED PLASTIC LABELS.

27. REPAIR AND PAINT ANY AREA THAT HAS BEEN DAMAGED IN THE COURSE OF THE ELECTRICAL WORK.28. PENETRATIONS IN FIRE RATED WALLS SHALL BE FIRE

STOPPED IN ACCORDANCE WITH LOCAL BUILDING CODE.
29. DRILLING OR CORING HOLES INTO CONCRETE WALLS,
WHETHER FOR FASTENING OR ANCHORING PURPOSES, OR
PENETRATIONS THROUGH THE FLOOR FOR CONDUIT RUNS,
PIPE RUNS, ETC., REQUIRES THAT TENDONS OR
REINFORCING STEEL MUST BE SEARCHED FOR BY
APPROPRIATE METHODS AND EQUIPMENT (X-RAY OR
OTHER DEVICE) THAT CAN ACCURATELY LOCATE THEM.
TENDONS OR REINFORCING MUST NOT BE DRILLED, CUT

OR DAMAGED UNDER ANY CIRCUMSTANCES.

30. UPON COMPLETION OF WORK, CONDUCT CONTINUITY, SHORT CIRCUIT, AND FALL POTENTIAL GROUNDING TESTS FOR APPROVAL. SUBMIT TEST REPORTS TO PROJECT MANAGER. CLEAN PREMISES OF ALL DEBRIS RESULTING FROM WORK AND LEAVE WORK IN A COMPLETE AND UNDAMAGED CONDITION.

31. CONTRACTOR TO COORDINATE WITH UTILITY COMPANY FOR CONNECTION OF BOTH TEMPORARY AND PERMANENT POWER TO THE SITE. THE TEMPORARY POWER AND ALL HOOKUP COSTS TO BE PAID BY CONTRACTOR.

32. CONTRACTOR SHALL PROVIDE LABOR AND MATERIALS
AS NECESSARY TO COMPLETE THE INSTALLATION OF
ANY TOWER LIGHTING SYSTEM DESCRIBED IN THE RFQ.

3. WIRE:

A. ALL 20 AMP CIRCUITS TO HAVE #12 THHN WIRING.
B. ALL 40 AMP CIRCUITS TO HAVE #8 THHN WIRING.
C. ALL 60 AMP CIRCUITS TO HAVE #6 THHN WIRING.

34. ALL DC GROUNDING CONDUCTORS TO BE TERMINATED WITH 1/4" STUD RING TYPE TERMINALS FOR THE APPROPRIATE SIZE OF WIRE.

35. PANEL SCHEDULE SHALL BE ACCURATELY IDENTIFIED AND PRINTED WITH AN ADHESIVE TYPE LABEL MAKER (KROY, BROTHER, OR EQUAL). NOTE: EMBOSSED MARKER SHALL NOT BE USED.

36. USE FLEXIBLE LIQUIDTITE NONMETALLIC CONDUIT AND FITTINGS FOR FINAL CONNECTION TO RECTIFIER CIRCUITS TO ISOLATE THE CONDUIT GROUND (SEE ALSO NEC ARTICLE 2505, WHICH SPECIFIES ALL GROUND RINGS, REBAR AND/OR UFER GROUND, AND GROUND RODS TO BE EFFECTIVELY BONDED WITH "NON-REVERSING" TYPE SPLICES).

37. SMOKE DETECTORS TO SHUT DOWN AC UNIT AND EXHAUST FAN WHEN ACTIVATED.

38. EXTERIOR GROUNDING SYSTEM FOR METER AND SERVICE BY ELECTRICAL CONTRACTOR.

39. WHEN ONE—WAY FOOTAGE FROM THE UTILITY TRANSFORMER CONNECTIONS TO THE SERVICE DISCONNECT MEANS (LINE TERMINAL LUGS) IS LESS THAN 15' AND THE UTILITY TRANSFORMER IS 2% IMPEDANCE OR LOWER; USE A FUSED DISCONNECT WITH RK1 FUSES ("SQ D" D224NRB).

CERTIFICATION

HERBOY CERTIPY THAT THIS DRAWING

WAS PREPARED BY ME, OR UNDER MY

DIRECT SUPERVISION, AND THAT THAN

DIRECT SUPERVISION, AND THAT THAN

CONTRACT SUPERVISION AND THAT THAN

CONTRACT SUPERVISION

CONTRACT S



Bussell Companies, Inc. 16026 Minnetonka Blvd., St. 100 Minnetonka, MN 55345-1301 952-931-2111 www. bussellcompanies.com



9973 VALLEY VIEW RD. EDEN PRAIRIE, MN 55344 (952) 903-9299 WWW.DESIGN1EP.COM

# VERIZON WIRELESS

10801 BUSH LAKE ROAD BLOOMINGTON, MN 55438 (612) 720-0052

PROJECT 20130877266 LOC. CODE: 265758

MINC RUSH CREEK CROWN CASTLE BU #825666


LAWNDALE LANE N MAPLE GROVE, MN 55311

SHEET CONTENTS: ELECTRICAL GENERAL NOTES

DRAWN BY:	AB
DATE:	02-19-14
CHECKED BY:	DB
REV. A	09-16-13
REV. A.1	05-08-14
REV. B	06-04-14
REV. C	06-12-15
REV. D	03-21-16
REV. E	04-12-16
REV. G	02-07-17

#### **GENERAL NOTES**

- A. REFER TO WALL ELEVATION SECTIONS SHEETS FOR MOUNTING HEIGHTS.
- B. CIRCLES WITH NUMBERS INSIDE REPRESENT EQUIPMENT NUMBERS. SEE EQUIPMENT LIST.
- C. SEE FIXTURE SCHEDULE FOR FIXTURE INFORMATION.
- D. ALL CONDUCTORS SHALL BE TYPE THHN.
- E. ALL CONDUITS TO BE 1/2" UNLESS NOTED OTHERWISE.

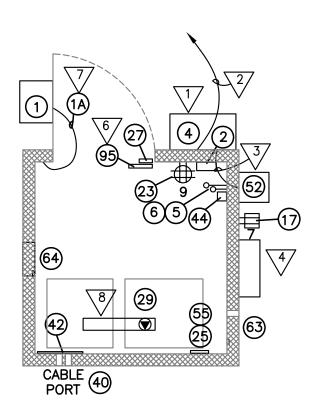


#### **KEYED NOTES**

- 77 PANELBOARD G1A (EQ#4).
- 2" RIGID CONDUIT 2#3/0+1#1/0N+1#6G FROM EQ#4 UTILITY MAIN CIRCUIT BREAKER THRU LB TO DISCONNECT. SEE SHEET E-1 FOR ROUTING INFORMATION.
- 2" RIGID CONDUIT 2#3/0+1#1/0N+1#6G FROM 200A GENERATOR CIRCUIT BREAKER IN EQ#4 CABINET TO CAM-LOC.
- TELCO ENTRY. WALL PENETRATION LOCATION WILL BE DETERMINED ON SITE. SEE DETAIL 1/E1 FOR CONDUIT ROUTING.
- To hydrogen detector system. Mount H2 sensor on ceiling. Mount interface module on wall. Provide DC Power from Battery Cabinets. Connect to relay for control of venting system (see sheet e5 connection diagram).
- POWER DOOR LOCK FROM DC CABINETS. PROVIDE 4"X4" J-BOX ON CEILING WITH TWO 1/2"C FROM MASTER LOCK BOX MOUNTED ON WALL TO DC CABINETS.
- CONNECT DOOR MOUNTED HVAC UNIT VIA 4' BLACK FLEXIBLE CORRUGATED SEAL TIGHT.

  PROVIDE 2#12+1#12G FROM UNIT TO J-BOX MOUNTED INSIDE NEXT TO DOOR. PROVIDE

  4#12+1#12G FROM J-BOX TO HVAC SHUTDOWN RELAY. PROVIDE 2#12+1#12G TO CIRCUITS 1,3

  IN PANEL G1A. PROVIDE 30A WP DISCONNECT IF REQUIRED BY AHJ.
- PROVIDE WIREWAY WITH FOUR L6-30 TWIST LOCK RECEPTACLES MOUNTED INSIDE FOR PLUGGING IN RECTIFIERS. PROVIDE 2-1" CONDUITS FROM WIREWAY TO PANELBOARD RECTIFIER BREAKERS. LOCATE ON CEILING. SITE VERIFY EXACT LOCATION OF EQUIPMENT AND LOCATE WIREWAY ACCORDINGLY.

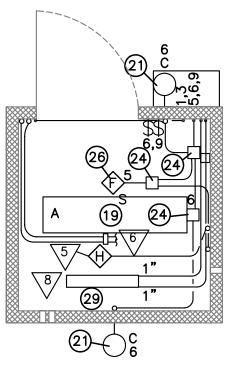







Bussell Companies, Inc 16026 Minnetonka Blvd., St. 100 Minnetonka, MN 55345-1301 952-931-2111 www.bussellcompanies.com



9973 VALLEY VIEW RD. EDEN PRAIRIE, MN 55344 (952) 903-9299 WWW.DESIGN1EP.COM

# VERIZON WIRELESS

10801 BUSH LAKE ROAD BLOOMINGTON, MN 55438 (612) 720-0052

PROJECT 20130877266 LOC. CODE: 265758

## MINC RUSH CREEK CROWN CASTLE BU #825666

LAWNDALE LANE N MAPLE GROVE, MN 5531

# SHEET CONTENTS:


POWER & LIGHTING
PLAN

DRAWN BY:	AB
DATE:	02-19-14
CHECKED BY:	DB
REV. A	09-16-13
REV. A.1	05-08-14
REV. B	06-04-14
REV. C	06-12-15
REV. D	03-21-16
REV. E	04-12-16
REV. G	02-07-17



# 6,9 LV1,3 EXIT 24 OUT TO LIGHT R CORRUGATED NTD ON OUTSIDE OF DOOR OU



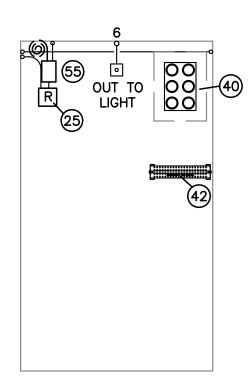







5 DOOR LOCK INSTALLATION PHOTOS
SCALE: NONE

### **KEYED NOTES**

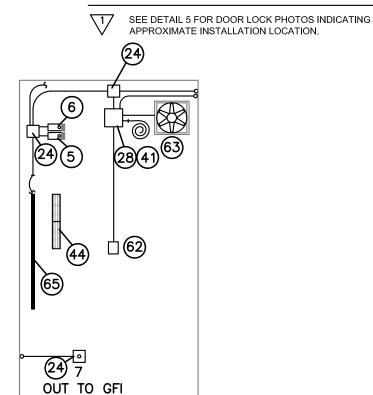


2 ELECTRICAL WALL ELEVATION "B"
SCALE: 3/8" = 1'-0"

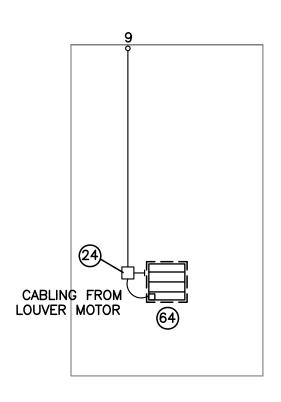

ELECTRICAL WALL ELEVATION "D"

SCALE: 3/8" = 1'-0"

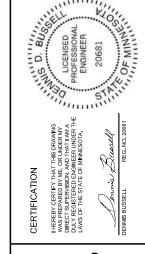



Bussell Companies, Inc. 16026 Minnetonka Blvd., St. 100 Minnetonka, MN 55345-1301 952-931-2111 www.bussellcompanies.com



9973 VALLEY VIEW RD. EDEN PRAIRIE, MN 55344 (952) 903-9299 WWW.DESIGN1EP.COM

# VERIZON WIRELESS

10801 BUSH LAKE ROAD BLOOMINGTON, MN 55438 (612) 720-0052

PROJECT 20130877266 LOC. CODE: 265758

# MINC RUSH CREEK CROWN CASTLE BU #825666

LAWNDALE LANE N MAPLE GROVE, MN 55311

#### SHEET CONTENTS:

ELECTRICAL INTERIOR
WALL ELEVATIONS

DRAWN BY:	AB
DATE:	02-19-14
CHECKED BY:	DB
REV. A	09-16-13
REV. A.1	05-08-14
REV. B	06-04-14
REV. C	06-12-15
REV. D	03-21-16
REV. E	04-12-16
REV G	02-07-17

E-4


3 ELECTRICAL WALL ELEVATION "C"
SCALE: 3/8" = 1'-0"

ELEVATION KEY


0

lacksquare


**(D)** 

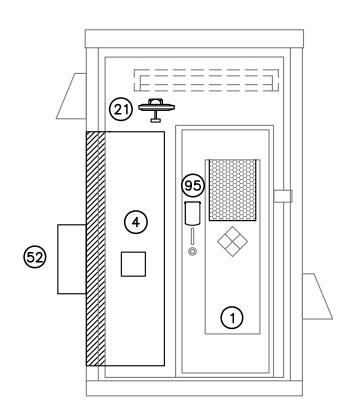

ELECTRICAL WALL ELEVATION "A" SCALE: 3/8" = 1'-0"

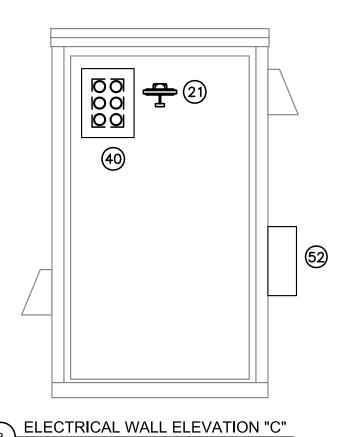


SCALE: 3/8" = 1'-0"

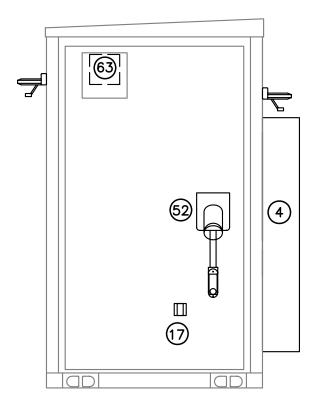


ELECTRICAL WALL ELEVATION "B"

SCALE: 3/8" = 1'-0"

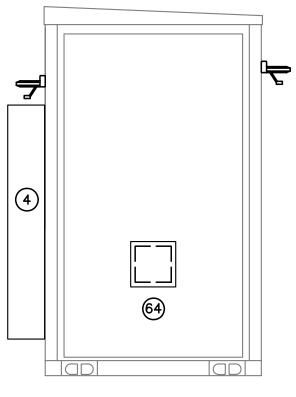

ELECTRICAL WALL ELEVATION "D" SCALE: 3/8" = 1'-0"

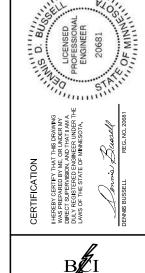



Bussell Companies, Inc. 16026 Minnetonka Blvd., St. 100 Minnetonka, MN 55345-1301 952-931-2111 www. bussellcompanies.com



9973 VALLEY VIEW RD. EDEN PRAIRIE, MN 55344 (952) 903-9299 WWW.DESIGN1EP.COM

# VERIZON WIRELESS

10801 BUSH LAKE ROAD BLOOMINGTON, MN 55438 (612) 720-0052

PROJECT 20130877266 LOC. CODE: 265758

# MINC **RUSH CREEK CROWN CASTLE** BU #825666

LAWNDALE LANE N MAPLE GROVE, MN 55311


# SHEET CONTENTS:

ELECTRICAL EXTERIOR
WALL ELEVATIONS

DRAWN BY:	AB
DATE:	02-19-14
CHECKED BY:	DB
REV. A	09-16-13
REV. A.1	05-08-14
REV. B	06-04-14
REV. C	06-12-15
REV. D	03-21-16
REV. E	04-12-16
REV. G	02-07-17

**B** 

**ELEVATION KEY** 

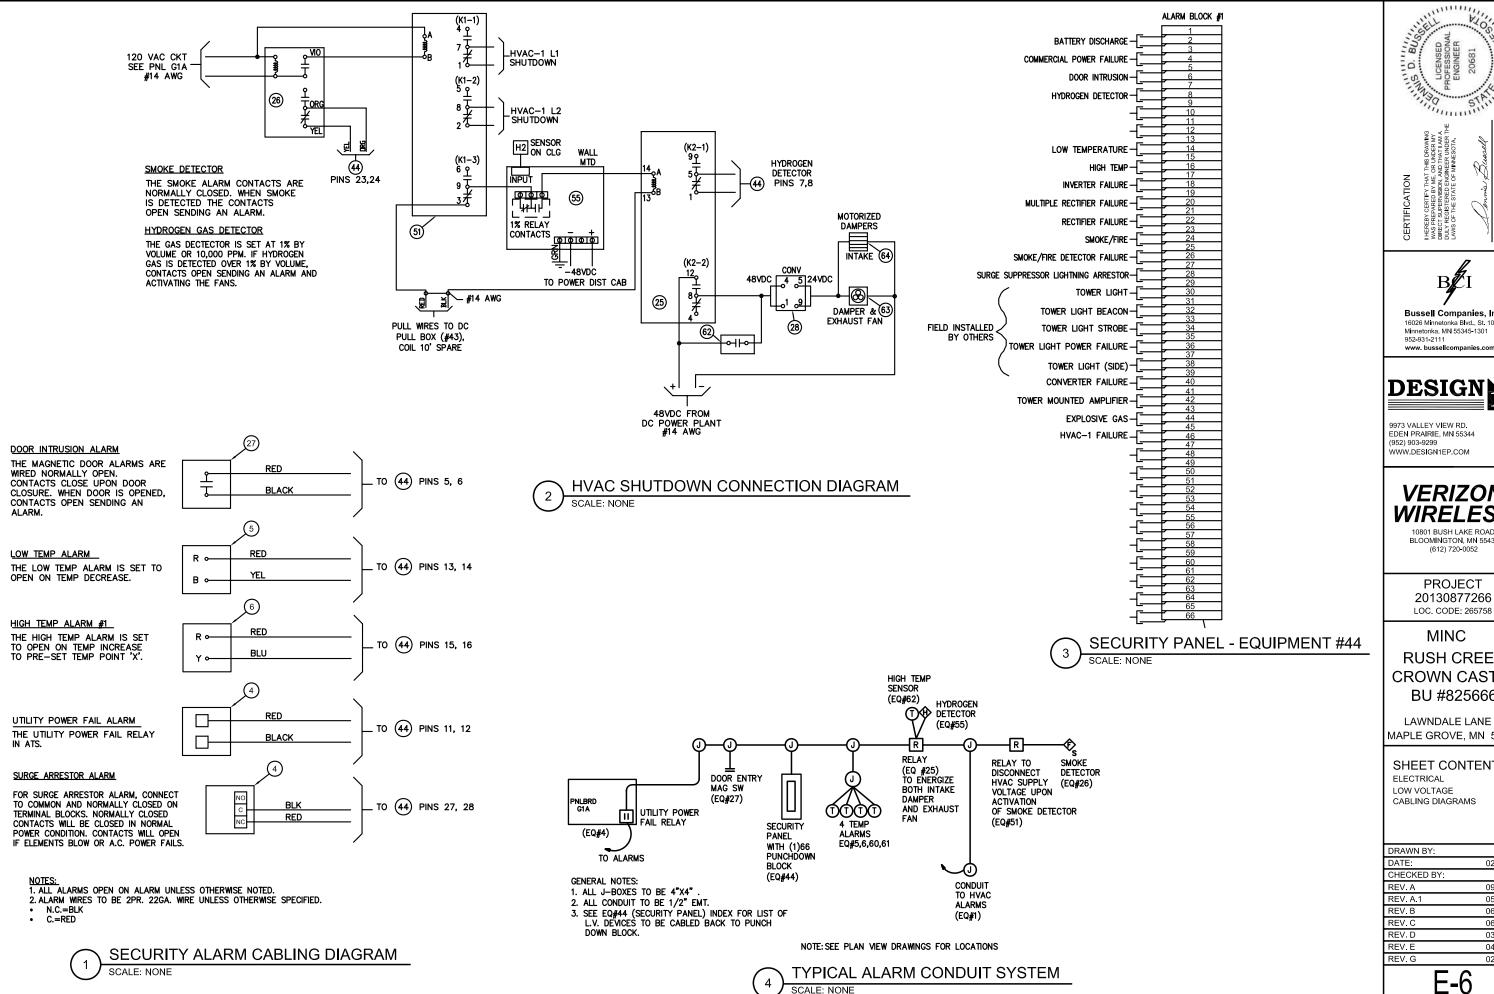



Bussell Companies, Inc. 16026 Minnetonka Blvd., St. 100 Minnetonka, MN 55345-1301 www. bussellcompanies.com

# **DESIGN**

9973 VALLEY VIEW RD EDEN PRAIRIE, MN 55344 (952) 903-9299 /www.design1ep.com

# VERIZON

10801 BUSH LAKE ROAD BLOOMINGTON, MN 55438 (612) 720-0052

**PROJECT** 20130877266

MINC

# **RUSH CREEK CROWN CASTLE** BU #825666

LAWNDALE LANE N MAPLE GROVE, MN 5531

#### SHEET CONTENTS:

ELECTRICAL LOW VOLTAGE CABLING DIAGRAMS

DRAWN BY:	AB
DATE:	02-19-14
CHECKED BY:	DB
REV. A	09-16-13
REV. A.1	05-08-14
REV. B	06-04-14
REV. C	06-12-15
REV. D	03-21-16
REV. E	04-12-16
REV. G	02-07-17

PANEL - G1A MLO	120	\ 240	VO	LTS	S	1	PH	ASE		3 W	IRE			200A	мсв	
LOCATION	VOLT	5,0703,645.		R	T	B				K	Т		Т		AMPS	LOCATION
	Α	В	G	С		R	Т	A B	Т	R	R	С	G	Α	В	
EQ#1,1A 45 HVAC-1 2#12+1#12G	1380		-			20/2	1		2	20/2		S=2.	H			EQ#51 HVAC SHUTDOWN RELAY 4#12+1#12
(#.		1380	$\vdash$	H	Χ	8	3		4	366	_	<del></del>	H			
EQ# 28 SM DET 3#14	8		$\vdash$	$\vdash$	Χ	15/1	5	٠.	6	20/1			X	159		EC/S # 19, 21, 35 LIGHT FIXTURES 2#12+1#12G
EQ# 17 EXT RECEPTACLE(S) 2#12+1#12G		180		Х		20/1	7		8	20/1	Χ	2 8	L		52	EQ#28 FAN
Q# 23 RECEPTACLE(S) 2#12+1#12G	360			Х		20/1	9	■_	10					8		
PARE				Ш		20/1	11		12		_					
SPARE						20/1	13		14		_					
RECTIFIER #1 (FURN BY OTHERS) #8 AWG		1400		Х		30/2	15		16							
25	1400			x		:2	17		18							
RECTIFIER #2 (FURN BY OTHERS) #8 AWG	1	1400		х		30/2	19		20	30/2	60					SPARE RECTIFIER
	1400			х			21		22							w w
RECTIFIER #3 (FURN BY OTHERS) #8 AWG		1400		х		30/2	23		24	30/2						SPARE RECTIFIER
*	1400	i de de marco		Х		8	25		26	-						w
RECTIFIER #4 (FURN BY OTHERS) #8 AWG	1700	1400		X		30/2	27		28							
	1400	1400		X		-	29		30							
	1400		1	^			31		32		0	2 3				
				H	T		33		34				Н			
			$\vdash$	Н							V2					
	-			H	+		35		36		6	G 3	H			
			-	H			37		38			N = 5:	Н			
	-		-	$\vdash$	$\dashv$	_	39		40		_		Н			
					ال	-	41		42			-				<u> </u>
VOLT-AMPS PER L	INE A	4	750	07			1	В		721	2					
TOTAL VOLT-AMP	S = 147	719					Α	MPS	=		61.	33			LCL =	iii
NOTES:									-0.000	-			· Water			
	A. PULL R	ECTIFIER	CABL	ES 5-	O" P/	STE	ND O	FSEAL	TITE.	COIL	AND	TAG.	VEF	RIFIER RE	CTIFIERL	OCS ON ARCHITECTURAL SHEETS.



	light fixture schedule										
		LAMPS									
TYPE	DESCRIPTION	QTY	WATT	CAT. NO.	MTG	VOLT	MFR/CAT NO.	NOTES			
A	1X4 LED LIGHT FIXTURE	1	50	LED 4000K	CLG	120V	LITHONIA: LBL4 LP840 OR EQUAL				
В	EMERGENCY EXIT W/BATTERY PACK	2	1.5	LED	WALL	120V	LITHONIA: ECRM6 OR EQUAL	2			
С	EXTERIOR LED WALL PACK	1	26	LED	WALL	120V	LITHONIA: OLW14 FCOS M24 W/OMS 1000 PHOTOSENSOR	1			


#### NOTES:


- 1. FIXTURE TO INCLUDE INTEGRAL PHOTOCELL.
- 2. CONNECT FIXTURE TO UNSWITCHED LEG OF CIRCUIT. MOUNT ABOVE DOOR.

	EQUIPMENT LIST-	ALL ITEMS FURN	ISHED, INSTALLED AND CONNECTED BY ELEC CONTRACTOR
EQ #	MANUFACTURER PART NO.	MANUFACTURER	DESCRIPTION
1	ECUA12ACA036S	MARVAIR	HVAC, 12,000 BTU, 230V
1A			4' BLACK FLEXIBLE CORRUGATED SEALTIGHT
2	8403-058	BARD	NON-PROGRAMMABLE THERMOSTAT W/ 4"X4" J.B.
4	AA300G-1PH-N-3R	INTERSECT	LOADCENTER, INTEGRATED 200A W/ATS
5	1UHH2	DAYTON	LOW TEMP ALARM THERMOSTAT, SPDT, 24-240VAC
6	1UHH2	DAYTON	HIGH TEMP ALARM THERMOSTAT, SPDT, 24-240VAC
17	15911	HUBBELL	20AMP GFCI DUPLEX RECEPTACLE / 2" X 4" W.P. J.B.
18	U5168-XTL-200	MILBANK, C-H	COMBINATION SERVICE ENTRANCE METER HUB & DISCONNECT 200A W/200A MCB
			208/1V W/BYPASS SWITCH (SHALL BE UTILITY APPROVED - VERIFY)
19	TYPE A - SEE FIXTURE SO	CHEDULE	INTÉRIOR LIGHT FIXTURE
20	CS120I	P&S	INTERIOR LIGHT SWITCH/ 2G J-BOX
21	TYPE C - SEE FIXTURE SO	CHEDULE	EXTERIOR LIGHT FIXTURE
23	CR201	P&S	20AMP DOUBLE DUPLEX RECEPTACLES / 2G J-BOX
24	4SD12	APPLETON	4" X 4" J.B. (1/2" & 3/4" KNOCKOUT)
25	RPM22ED	SCHNEIDER ELECTRIC	RELAY, 48VDC, DPDT, 8 PIN W/8 PIN BASE SMOKE DETECTOR / 4" X 4" J.B.
26	7100F	GENTEX	SMOKE DETECTOR / 4" X 4" J.B.
27	7939-2GY	ADEMCO	MAGNETIC DOOR ALARM
28	418CHB300W-48S24		DC TO DC POWER CONVERTER, 48VDC — 24 VDC
29			DC RECTIFIER TWIST LOCK AC OUTLETS (4 TWISTLOCKS) 4" WIREWAY, PUNCHED RECEPTACLES, 30A, TW, 240V
35	TYPE B - SEE FIXTURE SO	CHEDULE	BATTERY BACK-UP EMERGENCY LIGHT
37	ASE6X6X4	HOFFMAN	ENCLOSURE 6" X 6" X 4" (HVAC SHUTDOWN)
41		STEEL CITY	6" X 6" J-BOX W/1" KNOCKOUTS
42	196632	_	1/4" X 4" X 16" TELEPHONE BD GROUND BAR (TINNED)
43	4SDEK	APPLETON	4" X 4" J.B. (1/2" & 3/4" KNOCKOUT) 24 VCD PULL BOX
44	AHE16X12X6	SIEMONS	1-66 PAIR PUNCH DOWN ALARM BLOCK
45	DPU222R	CUTLER HAMMER	30A WP DISCONNECT (HVAC) IF REQUIRED BY LOCAL AHJ
47		_	2" LB
49	72171341	STEEL CITY	4 11/16" X 4 11/16" J.B.
51	21011-84	DELTROL	120 VOLT RELAY 8 PIN 30A (HVAC SHUTDOWN)
52	1CGC-1P	INTERSECT	200A CAM-LOC GENERATOR CONNECTOR
55	SBS-H2	STORAGE BATTERY SYSTEMS	HYDROGEN GAS DETECTOR, 12-48VDC INPUT
56	SMF050BEC	HAMMOND (HPS)	50KVA 208/1V TO 240/1V TRANSFORMER, NEMA 3R WITH DRIP PLATE
57		C-H, GE, SQ D	200A 240V H-DUTY, WEATHERPROOF SERVICE-RATED DISCONNECT SWITCH
62	1UHH2	DAYTON	HIGH TEMP THERMOSTAT (CONTROL EXHAUST FAN)
63	PFFP-200-D24-01-FS	THERMAL EDGE INC.	10" X 10" EXHAUST FAN, +24VDC, 300CFM
64	MS8105A1030	HONEYWELL	12" X 12" MOTORIZED LOUVER W/SHROUD HOOD FOR INTAKE VENT, 24VAC/DC
65	89-610		BARRIER STRIP (BS), 12 CIRCUIT, 30A, 300V
95	7221 (KIT 2172 GRP)	MASTER LOCK	DOOR LOCK - INPUT RATING +/- 15-60VDC
_ 33	1/221 (NII 21/2 GRF)	I MINGTEN LOCK	1 DOON LOOK 1141 OF INCHING TY - 10-004DC



POWER	DISTRI	BUTION	LIGHTING	LIGHTING DEVICES					
4	STARTE	BRANCH CIRCUIT PANELBUARD  R AND CUNTRUL	□ o •		FLUDRESCENT - CEILING VALL/CEILING MOUNTED FIXTURE FIXTURE ON EMERGENCY POVER/EGRESS LIGHTING				
RACEWA	Y	MOTOR CONNECTION DISCONNECT OR SAFETY SWITCH	<del>     </del>   ^ /		EMERGENCY BATTERY FIXTURE  LIGHT FIXTURE TYPE DESIGNATION - SEE SCHEDULI SWITCH DESIGNATION (0,6,c,d,e,ETC.)				
		CONCEALED RACEWAY SURFACE MTD RACEWAY	₩a  -®		SINGLE POLE SVITCH PHOTO CELL				
ONE-LI	NE/RISI	ER DEVICES	NOTE SYMBOLS						
무점②		GENERATOR AUTOMATIC TRANSFER SWITCH DISCONNECT SWITCH	0	*******	ELECTRICAL NOTE REFERRAL (SEE NOTE ON DRAWINGS) EQUIPMENT NUMBER				
∩ R		CIRCUIT BREAKER RELAY	ELECTRI	CAL ANI	COMMUNICATION DEVICES				
T	*******	TRANSFORMER	<del>0</del>		RECEPTACLE (DUPLEX) RECEPTACLE (DUPLEX GFI)				
FIRE AL	ARM D	EVICES	_ _ _ _	********	JUNCTION BOX (WALL/CEILING MTD.)				
<b>₽</b> s		SMOKE DETECTOR HYDROGEN DETECTOR FIRE ALARM CONTROL PANEL (FACP		********	TELEPHONE DUTLET (VALL MOUNTED)				
	*******	TARE REPROPULIED FRIEL WACE	1						

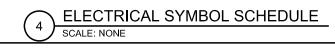

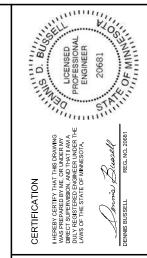



Bussell Companies, Inc. 16026 Minnetonka Blvd., St. 100 Minnetonka, MN 55345-1301 952-931-2111 www.bussellcompanies.com



9973 VALLEY VIEW RD. EDEN PRAIRIE, MN 55344 (952) 903-9299 WWW.DESIGN1EP.COM

# VERIZON WIRELESS

10801 BUSH LAKE ROAD BLOOMINGTON, MN 55438 (612) 720-0052

PROJECT 20130877266 LOC. CODE: 265758

# MINC RUSH CREEK CROWN CASTLE BU #825666

LAWNDALE LANE N MAPLE GROVE, MN 55311

SHEET CONTENTS: ELECTRICAL SCHEDULES

DRAWN BY:	AB
DATE:	02-19-14
CHECKED BY:	DB
REV. A	09-16-13
REV. A.1	05-08-14
REV. B	06-04-14
REV. C	06-12-15
REV. D	03-21-16
REV. E	04-12-16
REV G	02-07-17



# SITE SURVEY

**PARENT PARCEL DESCRIPTION:** (per Old Republic National Title Insurance Company Commitment No. 101587, dated June 19, 2013.)

The land referred to in this Commitment is described as follows:

The South 545.00 feet of the East 415.00 feet of the East 1/2 of the Southeast 1/4 of the Northeast 1/4 of Section 18, Township 119, Range 22, Hennepin County, Minnesota.

**G7<981 @ 16î 9L<-6 + G.** (per Old Republic National Title Insurance Company Commitment No. 101587, dated June 19, 2013.)

- 13.) Subject to an easement for road over and across the Easterly and Southerly 33.00 feet thereof as shown in Deed dated 7-6-95, filed 7-7-95 as Document No. 2619917.

  This document describes a 33' wide easement for roadway purposes and is as shown on the survey.
- 14.) Terms of Deed of Easement dated 9-12-70, filed 7-23-71 as Document No. 1003837.

  This document describes a 60' wide non-exclusive permanent easement for roadway purposes along with West line of the property. This easement does not affect the surveyed area and is not shown on the survey.
- 15.) Terms of Driveway Easement Grant dated 5—14—98, filed 5—26—98 as Document No. 3018713.

This document describes a 5' wide perpetual easement for driveway purposes along the West line of the property. This easement does not affect the surveyed area and is not shown on the survey.

## LAND SPACE DESCRIPTION:

That part of the East Half of the Southeast Quarter of the Northeast Quarter of Section 18, Township 119 North, Range 22 West of the Fifth Principal Meridian, Hennepin County, Minnesota, described as follows:

Commencing at the southeast corner of said East Half of the Southeast Quarter of the Northeast Quarter; thence South 89 degrees 42 minutes 00 seconds West along the South line of said East Half of the Southeast Quarter of the Northeast Quarter, a distance of 249.04 feet; thence North 0 degrees 00 minutes 03 seconds East, a distance of 224.48 feet; thence North 9 degrees 36 minutes 56 seconds East, a distance of 2.50 feet to the Point of Beginning of the land space to be described; thence North 0 degrees 00 minutes 00 seconds East, a distance of 11.00 feet; thence South 90 degrees 00 minutes 00 seconds West, a distance of 11.00 feet; thence North 90 degrees 00 minutes 00 seconds West, a distance of 9.00 feet to the Point of Beginning.

© 2017 WIDSETH SMITH NOLTING



SITE NAME: MINC RUSH CREEK

Hennepin County, MN

2	10/17/17	CLIENT COMMENTS					SMK	втв	ВТВ
1	5/1/17	CLIENT COMMENTS					SMK	втв	втв
No.	Date		REVISIONS					CHK	APP'D
FIE	LD WORK	: 5/8/13	CHECKED BY:	ВТВ		DRAWN BY: JMB/SMK/TH			

I HEREBY CERTIFY THAT THIS DOCUMENT WAS PREPARED BY ME OR UNDER MY DIRECT SUPERVISION AND THAT I AM A DULY LICENSED LAND SURVEYOR UNDER THE LAWS OF THE STATE OF MINNESOTA

SIGNATURE: BRYAN T. BALCOME, L.S.

FULL SCALE ON 22"x34" HALF SCALE ON 11"x17" 0494A0608.010



SHEET 1 OF 2 SHEETS

